PROPOSED TWO STOREY DWELLING WITH POOL AT 9 QUEENSBURY ROAD, PADSTOW HEIGHTS (Lot A)

DRAWING LIST				
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A01.01	DEMOLITION PLAN			
A01.02	SITE PLAN & ROOF PLAN, SITE ANALYSIS PLAN			
A01.03	WASTE MANAGEMENT PLAN AND SEDIMENT & EROSION CONTROL PLAN			
A01.04	LANDSCAPING PLAN			
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A06.01	LONGITUDINAL SECTION			
A07	3D_GROUND AND FIRST FLOOR			
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A13.04	3 HOURS OF SUNLIGHT TO LIVING - 21ST JUN			
A13.05	3 HOURS OF SUNLIGHT TO 50% POS - 20TH MAR			
A14	BASIX REQUIREMENTS			
A15	NOTIFICATION PLANS			



ALL STANDARDS AND CODES INCLUDING BUT NOT LIMITED TO THE BCA/ NCC AND ANY REFERENCED AS/NZS STANDARD TO APPLY AND BE CONFORMED WITH AS REQUIRED.

- ALL DEMOLITION WORK IS TO BE CARRIED OUT IN ACCORDANCE WITH AS 2601 - 2001 (THE DEMOLITION OF STRUCTURES)

- CONVENTIONAL TIMBER ROOF FRAMING TO COMPLY WITH AS 1684.4-2006 TIMBER FRAMING CODE - COMPLY WITH PART 3.4.3 OF BCA - WALL CLADDING 3.5.3

- STEEL ROOF TO BE INSTALLED WITH A THERMAL BREAK WITH R-VALUE OF NOT LESS THAN 0.2 IN ACCORDANCE WITH NSW 13.2.3. (1)(2) OF BCA 2022

- METAL FRAME EXTERNAL WALLS TO BE INSTALLED WITH A THERMAL BREAK WITH AN R-VALUE OF NOT LESS THAN 0.2 IN ACCORDANCE WITH NSW 13.2.5(1)(2)

- STEEL STRUCTURES TO AS 4100

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DESCRIPTION

- RESIDENTIAL SLABS AND FOOTINGS TO AS 2870
- DAMP PROOF COURSE AND FLASHINGS TO AS 2904

- All Glazing to be in accordance with H1 D8 of BCA 2022

-SKYLIGHTS, EXTERNAL WINDOWS AND DOORS, EXHAUST FANS, CONSTRUCTION OF CEILINGS, WALLS AND FLOORS, EVAPORATIVE COOLERS TO BE SEALED IN

ACCORDANCE WITH PART 13.4.(2)(3)(4)(5)(6)(7) OF BCA 2022. - INSULATION MUST COMPLY WITH AS/NZS 4859.1 AND TO BE INSTALLED IN ACCORDANCE WITH PART 13.2.2(1)(2)(3) OF BCA 2022

- INSULATION OF SERVICES, CENTRAL HEATING WATER PIPING, HEATING AND COOLING DUCTWORK TO BE COMPLETED IN ACCORDANCE WITH PART 13.7(2)(3)(4) OF BCA 2022. - HARD WIRED SMOKE ALARM TO BE INSTALLED IN ACCORDANCE WITH PART NSW 9.5.1 OF NCC 2022

- WATERPROOFING TO WET AREAS AND BATHROOM CONSTRUCTION TO BE IN ACCORDANCE WITH AS 3740-1994 WATERPROOFING OF WET AREAS WITH IN RESIDENTIAL BUILDINGS + PART 2.1, PART3.8.1 OF BCA

> **PROPOSED TWO** COPYRIGHT All rights reserved All rights reserved. These drawings, plans and specifications and the copyright are the property of Nemco Design and must not be used, reproduced or copied wholly or in part without the written permission of Nemco Design. 9 QUEENSBURY M: 0422 606 22 Lo NEMCO DESIGN C STRUCTURAL ENGINEERING & ARCHITECTURAL DESIGN

WITH PART 3.4.1 OF THE BCA. BCA

- ALL MASONRY WALLS TO HAVE EXPANSION JOINTS TO COMPLY WITH BCA REQUIREMENTS

- FIRE RATED MASONRY WALL WITH AN FRL OF 60/60/60 AS PER PART 9.2.3 OF NCC 2022 - A HIGH IMPACT VAPOR BARRIER TO COMPLY AS PER THE REQUIREMENTS OF CLAUSE 3.2.2.6 OF THE BCA

- GUTTERS AND DOWNPIPES TO COMPLY WITH AS 3500.3 OR 3500.5 - ALL ENCLOSED WATER CLOSET DOORS ARE TO SWING OUT OR TO BE PROVIDED WITH LIFT OFF HINGES OR THE LIKE IF THE DOOR IS WITHIN 1200MM OF THE PAN IN

ACCORDANCE WITH THE REQUIREMENTS OF CLAUSE 3.8.3.3 OF VOLUME 2 OF THE NCCS (BCA)

- ALL STAIRS WILL BE CONSTRUCTED IN ACCORDANCE WITH THE REQUIREMENTS OF CLAUSE 3.9.1.2 OF VOLUME 2 OF THE NCCS-BCA

- THE FINISH OF ALL OF THE STAIRS WILL MEET THE REQUIREMENTS OF CLAUSE 3.9.1.4 OF VOLUME 2 OF THE NCCS-BCA

- ALL LANDINGS PROVIDED WILL MEET THE REQUIREMENTS OF CLAUSE 3.9.1.5 OF VOLUME 2 OF THE NCCS-BCA

- PAINTING TO AS 2311


- HOUSING WIND LOADINGS AS 4055 - MECHANICAL VENTILATION TO BE PROVIDED AS PER BCA PART 10.6.3, 10.8.2 & 10.8.3


- TREATMENT FOR THE PROTECTION OF THE BUILDING FROM SUBTERRANEAN TERMITES SHALL BE CARRIED OUT IN ACCORDANCE WITH AS 3660.1. IN SELECTING APPROPRIATE MATERIAL + COMPLY WITH PART 3.1.3 OF THE BCA - SUB FLOOR VENTILATION UNDER SUSPENDED FLOORS MUST BE IN ACCORDANCE

- NON-SLIP NOSING'S OR TREADS TO STAIRS TO COMPLY WITH CLAUSE 3.9.1.4 OF THE

- MASONRY CONSTRUCTION TO COMPLY WITH AS 3700

STOREY DWELLING WITH		DWG NUMBER:	ORIGINAL SIZE:
POOL Y ROAD, PADSTOW HEIGHTS	24554	A00	A3
ot A, DP 409706	DESIGNED BY: A.N.	DATE: 15.11.2024	
OVER SHEET	DRAWN BY:	SCALE:	(+)
	A.N.	AS SHOWN	

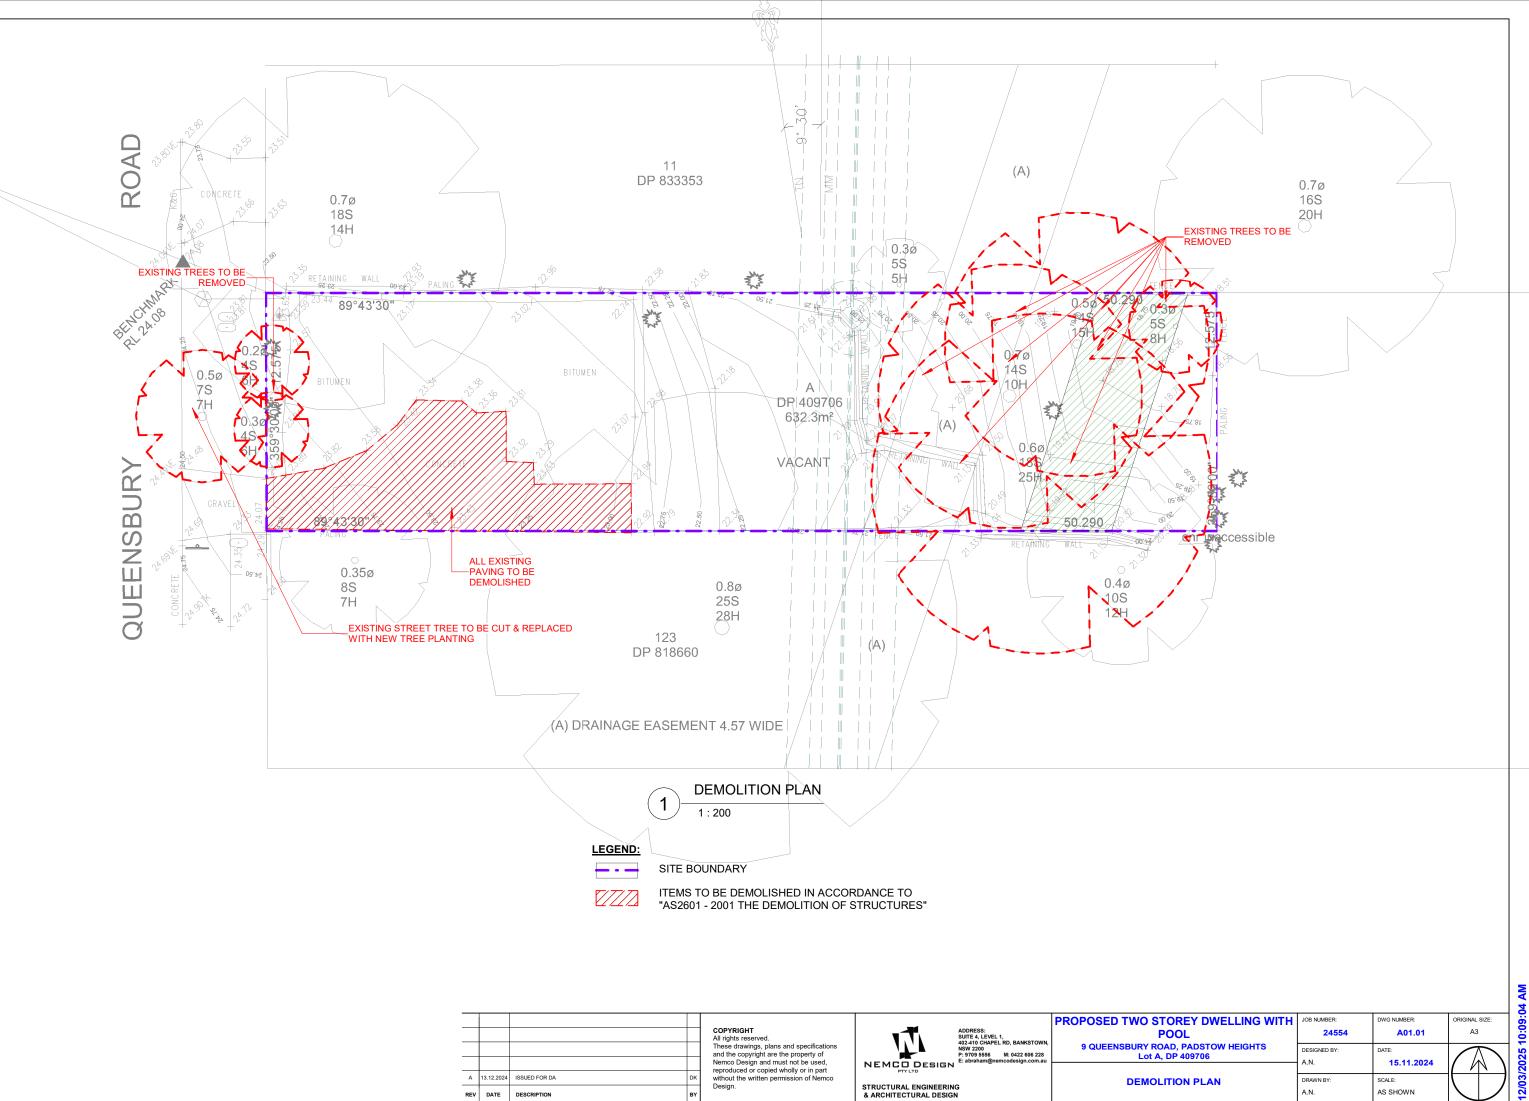

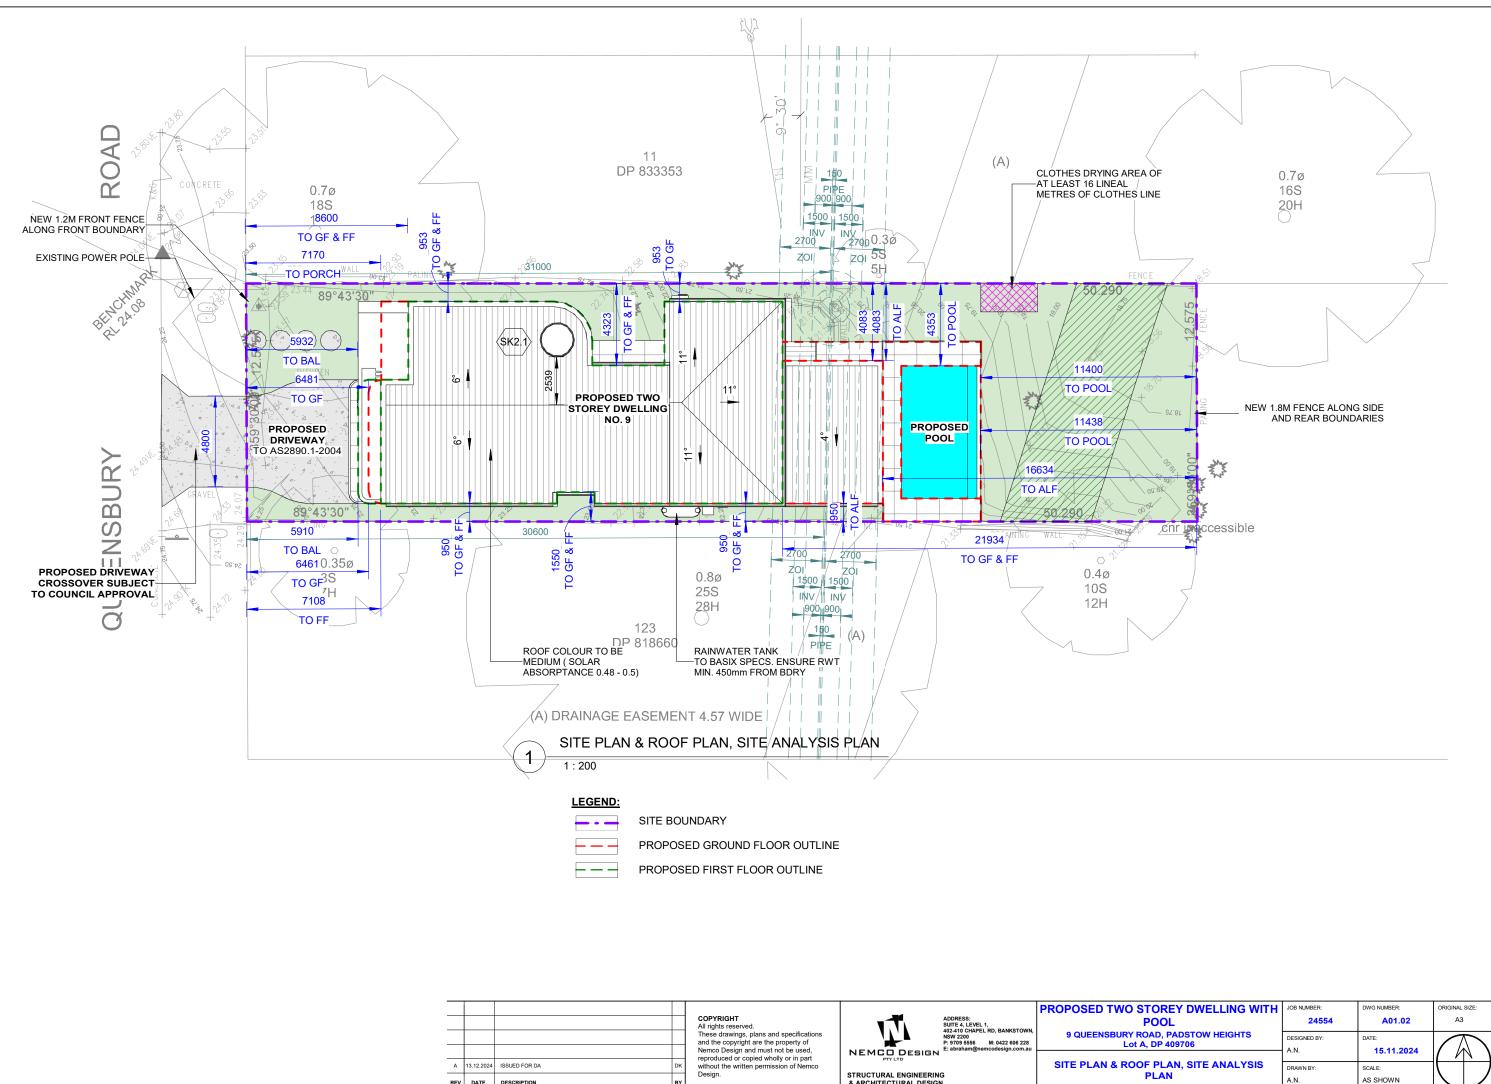

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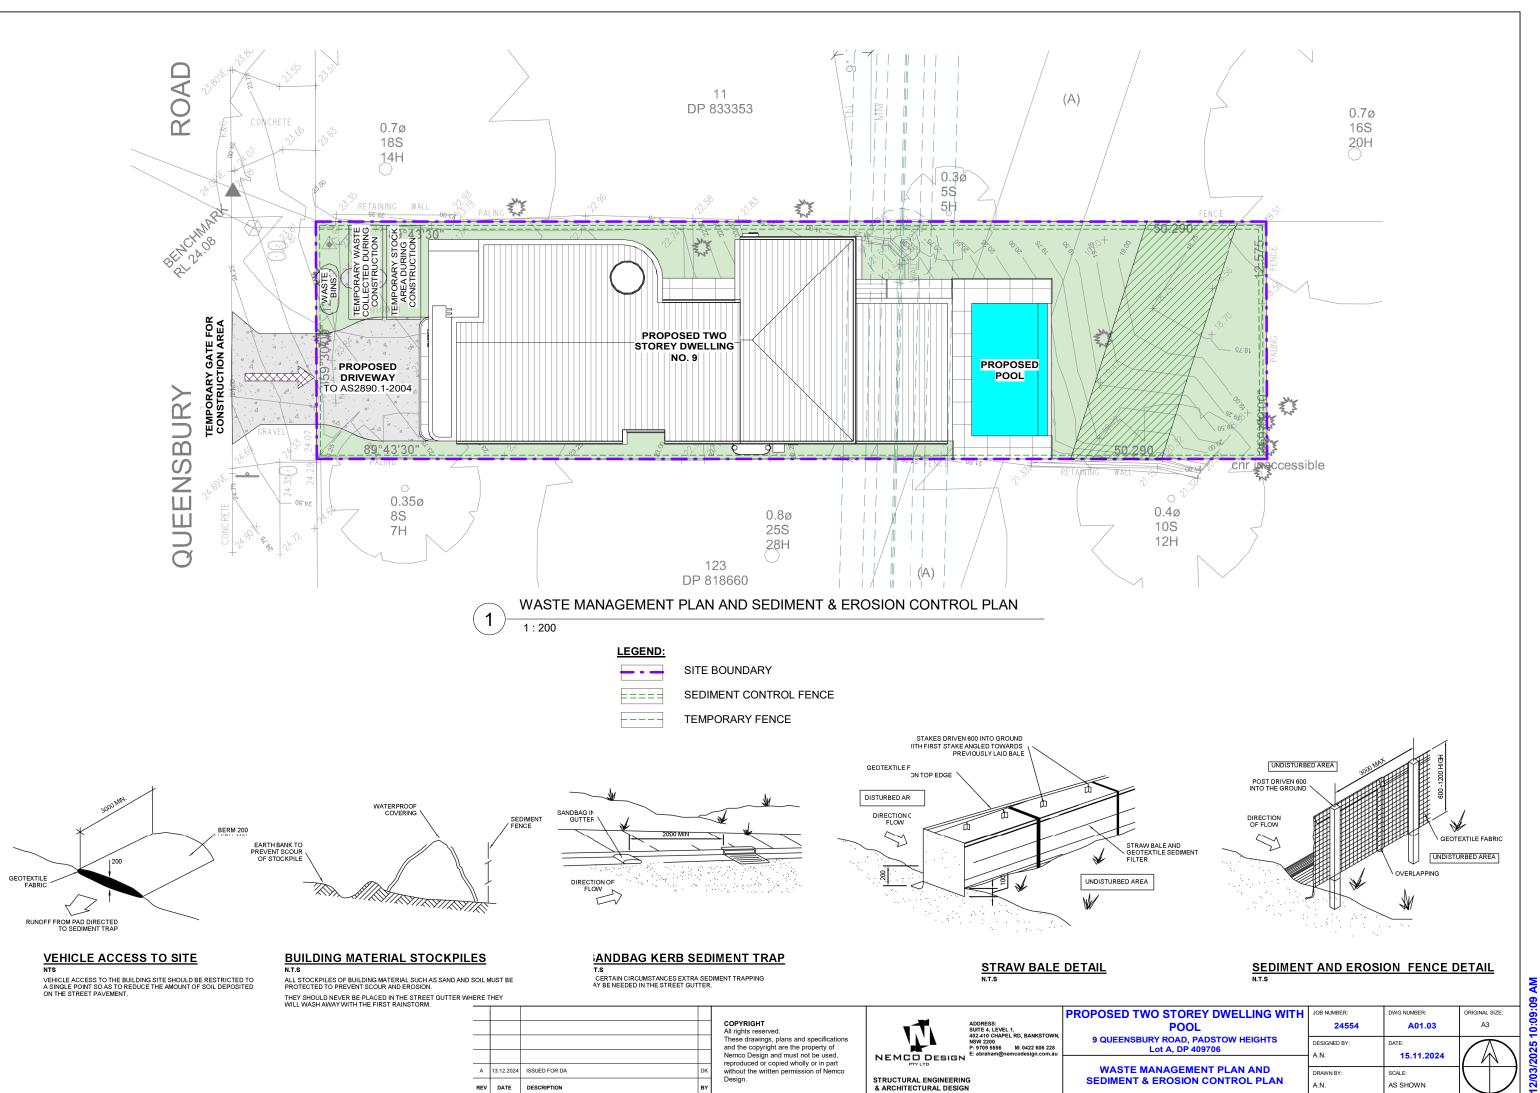
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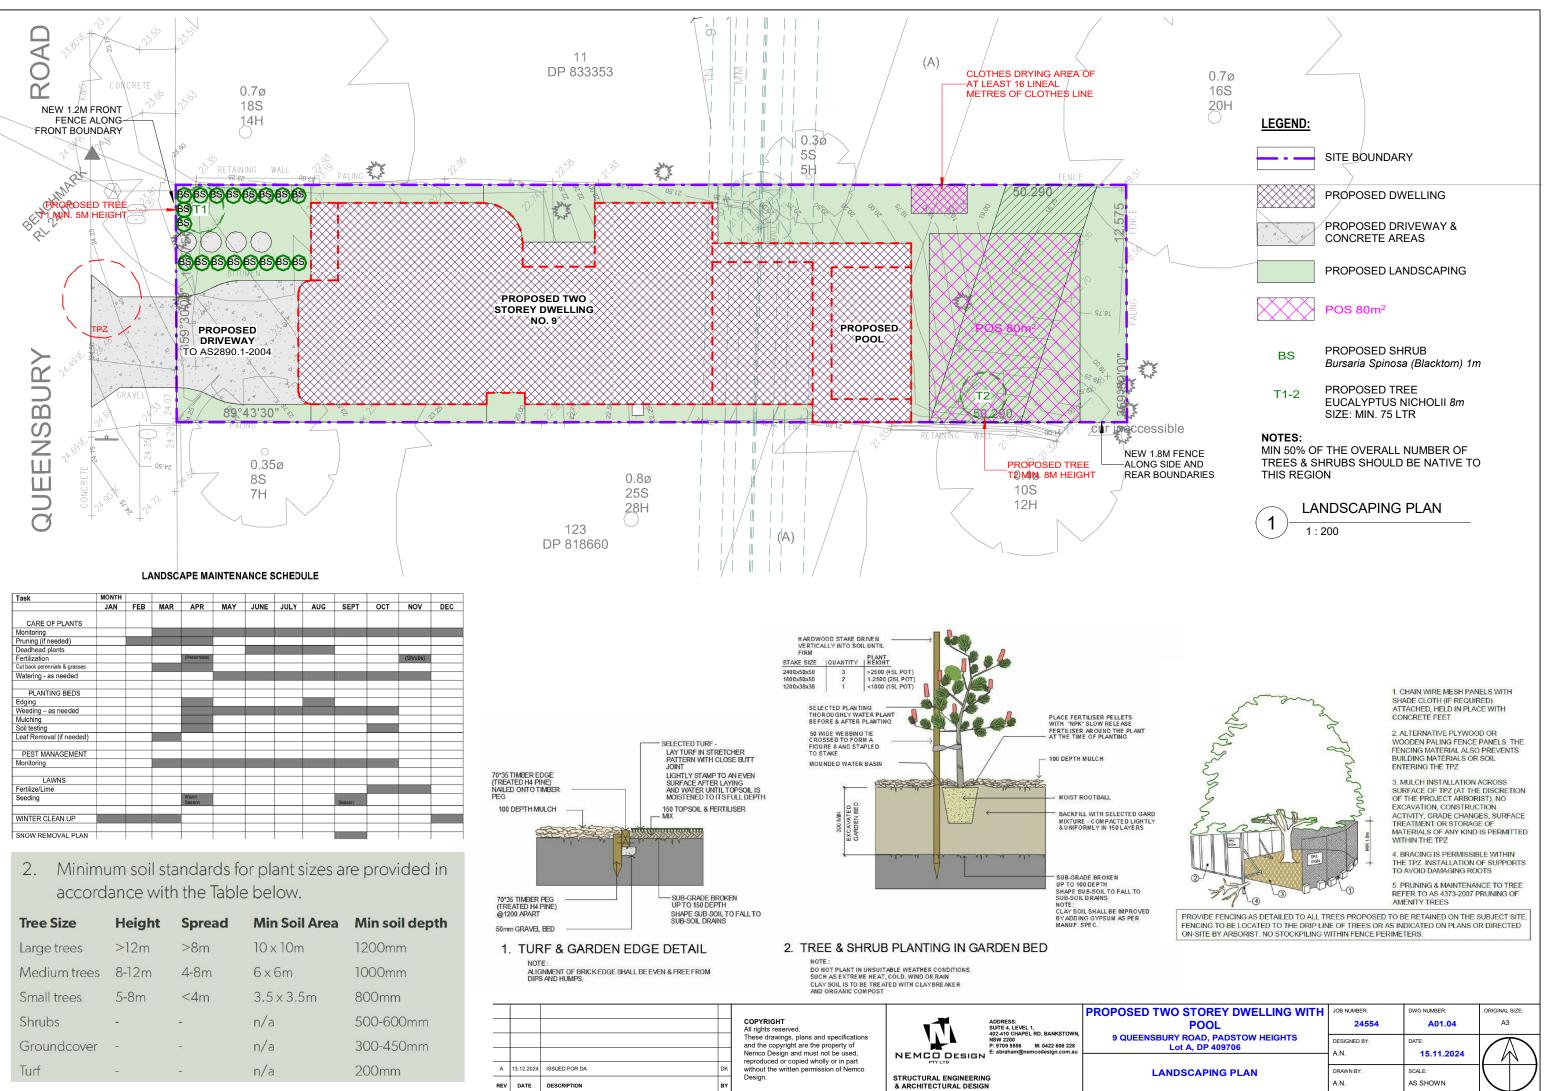
NEMCO DESIGN

STRUCTURAL ENGINEERING & ARCHITECTURAL DESIGN


ROPOSED TWO STOREY DWELLING WITH	JOB NUMBER:	DWG NUMBER:	ORIGINAL SIZE:
POOL	24554	A01.02	A3
9 QUEENSBURY ROAD, PADSTOW HEIGHTS	DESIGNED BY:	DATE:	
Lot A, DP 409706	A.N.	15.11.2024	
SITE PLAN & ROOF PLAN, SITE ANALYSIS	DRAWN BY:	SCALE:	\bigcirc
PLAN	A.N.	AS SHOWN	



D STOREY DWELLING WITH	JOB NUMBER:	DWG NUMBER:	ORIGINAL SIZE:
POOL	24554	A01.03	A3
Y ROAD, PADSTOW HEIGHTS ot A, DP 409706	DESIGNED BY:	DATE:	
	A.N.	15.11.2024	
NAGEMENT PLAN AND	DRAWN BY:	SCALE:	
EROSION CONTROL PLAN	A.N.	AS SHOWN	




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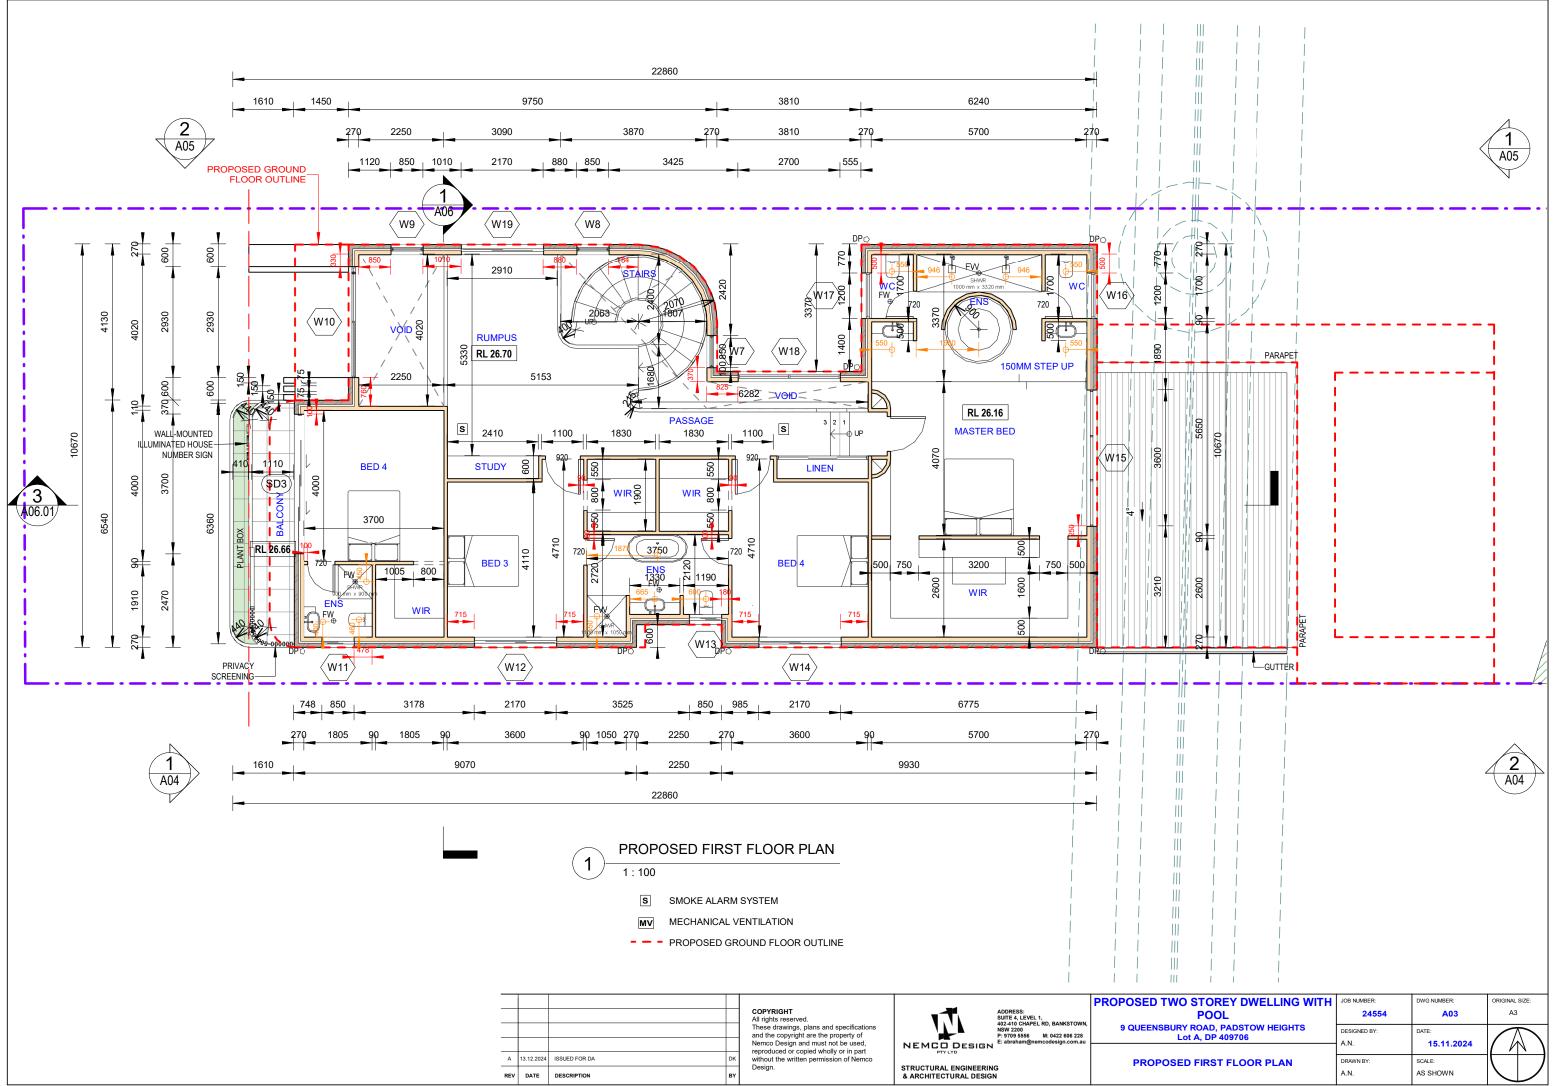
CULATIONS			
A CALCULATIONS			
	632.2m ²		
ROPOSED GROUND FLOOR: ROPOSED FIRST FLOOR:	153.2m² 161.5m²		
L IOWABLE FLOOR AREA AREA = 0.5 x 632.2m ²	316.1m ²		
TOTAL FLOOR AREA:	314.5m ²	>	316.1m ²
AGE CALCULATIONS			
SITE COVERAGE: ING, PORCH, ALFRESCO, & CONCRETE AREAS)	315.9m ²	(5	0.0%)
NG CALCULATIONS			
C. FORWARD OF BUILDING LINE: FORWARD AREA = 0.45 x 88.4m ²	39.8m ²		
LANDSCAPING AT FRONT:	46.3m ²	>	39.8m² OK
LANDSCAPING AT REAR:	192.5m ²		
TOTAL LANDSCAPING:	238.3m ²	(37.	7%)
RVIOUS AREA CALCULATIONS			
VIOUS AREA FORWARD OF BUILDING THE FORWARD AREA = 0.55 x 88.4m ²	48.6m ²		
IMPERVIOUS AREA AT FRONT: IVEWAY & PATHS)	43.2m ²	<	48.6m² OK

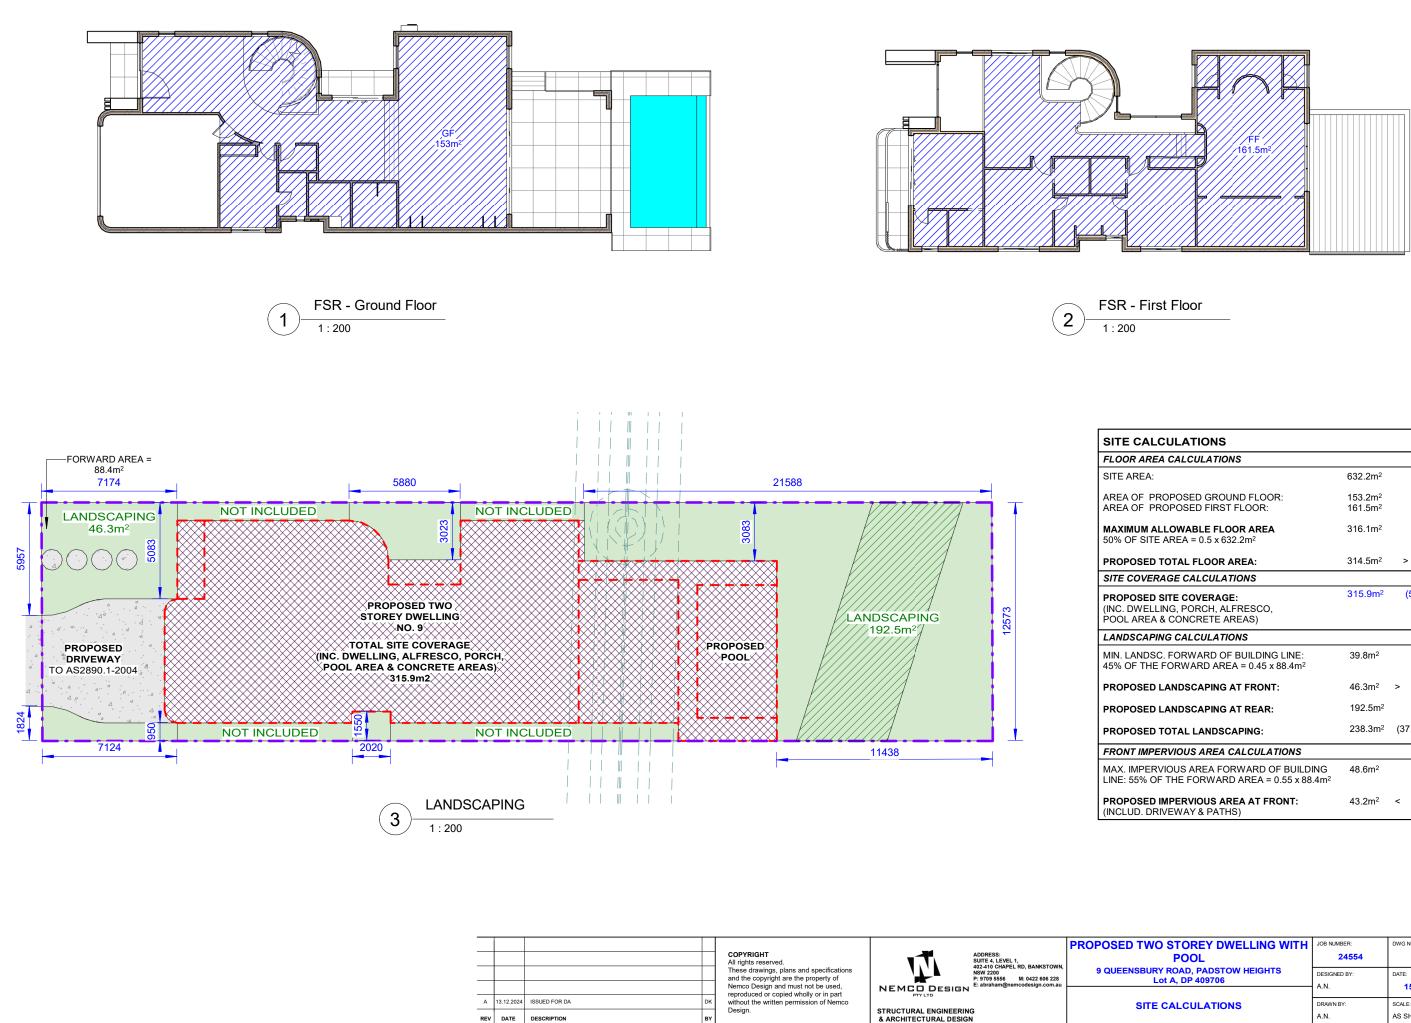O STOREY DWELLING WITH	JOB NUMBER:	DWG NUMBER:	ORIGINAL SIZE:
POOL	24554	A01.05	A3
Y ROAD, PADSTOW HEIGHTS .ot A, DP 409706	DESIGNED BY:	DATE: 15.11.2024	
	A.N.	15.11.2024	
CALCULATIONS	DRAWN BY:	SCALE:	
	A.N.	AS SHOWN	\searrow


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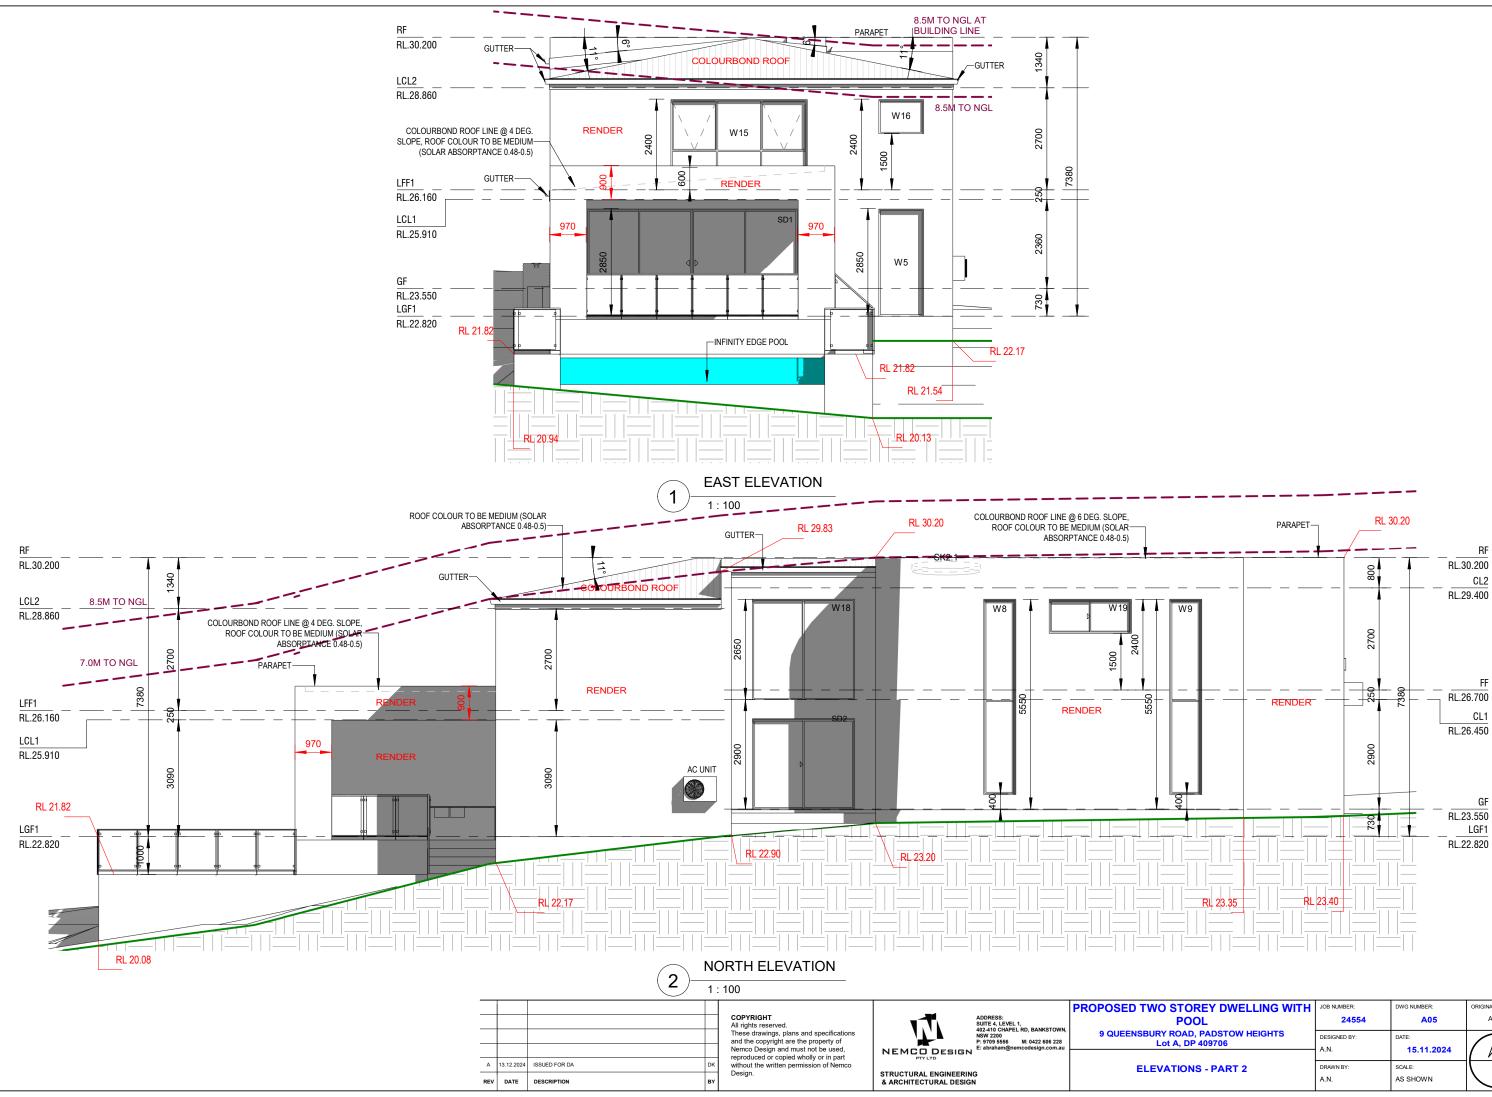
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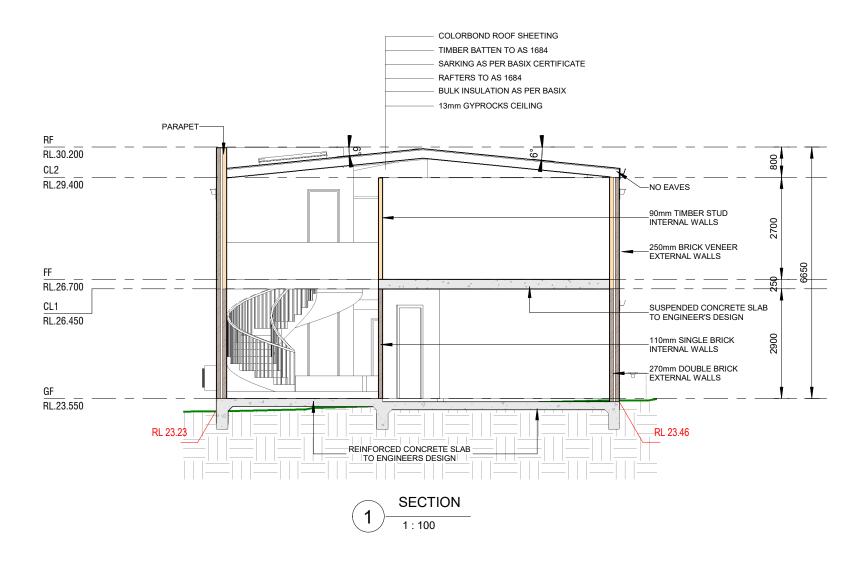



				3 AM
O STOREY DWELLING WITH POOL	JOB NUMBER: 24554	DWG NUMBER:	ORIGINAL SIZE: A3	10:09:23
Y ROAD, PADSTOW HEIGHTS ot A, DP 409706	DESIGNED BY: A.N.	DATE: 15.11.2024		
ATIONS - PART 1	DRAWN BY: A.N.	SCALE: AS SHOWN	\Box	12/03/2025

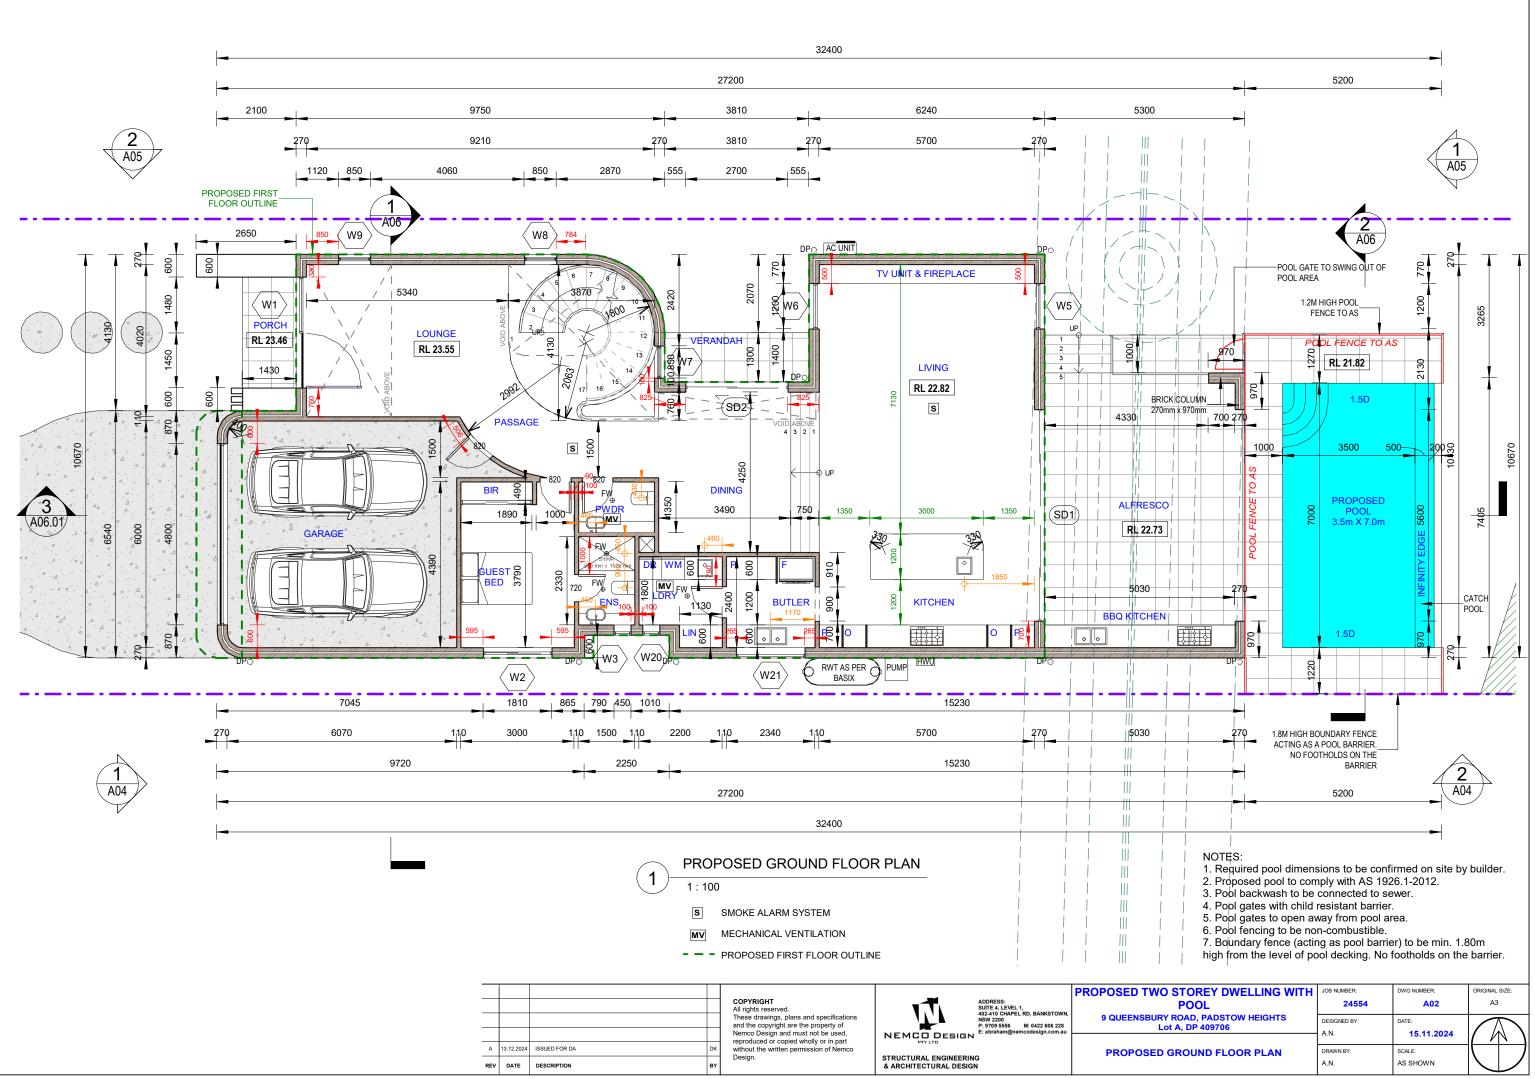

STOREY DWELLING WITH	JOB NUMBER:	DWG NUMBER:	ORIGINAL SIZE:
POOL	24554	A05	A3
Y ROAD, PADSTOW HEIGHTS ot A, DP 409706	DESIGNED BY:	DATE: 15.11.2024	
	A.N.	15.11.2024	
ATIONS - PART 2	DRAWN BY:	SCALE:	()
	A.N.	AS SHOWN	


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2 POOL SECTION

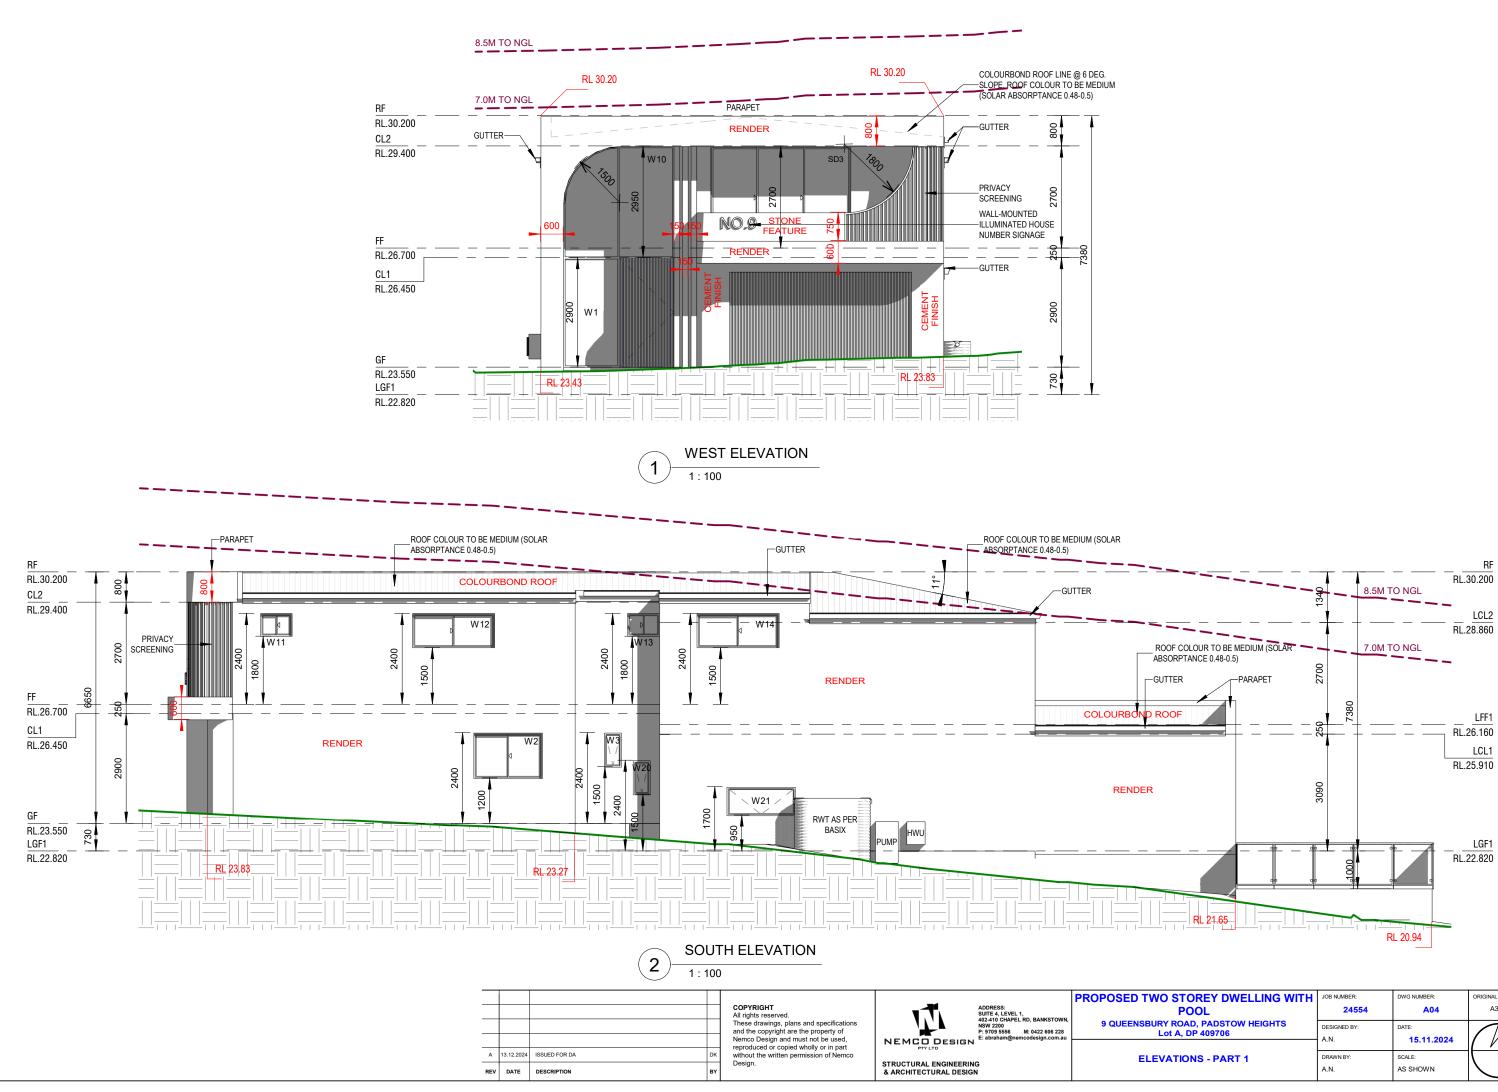
				COPYRIGHT All rights reserved.		ADDRESS: SUITE 4, LEVEL 1, 402-410 CHAPEL RD, BANKSTOWN.	PROPOSED TWO STOREY DWELLING WITH POOL	JOB NUMBER: 24554	DWG NUMBER: A06	ORIGINAL S	
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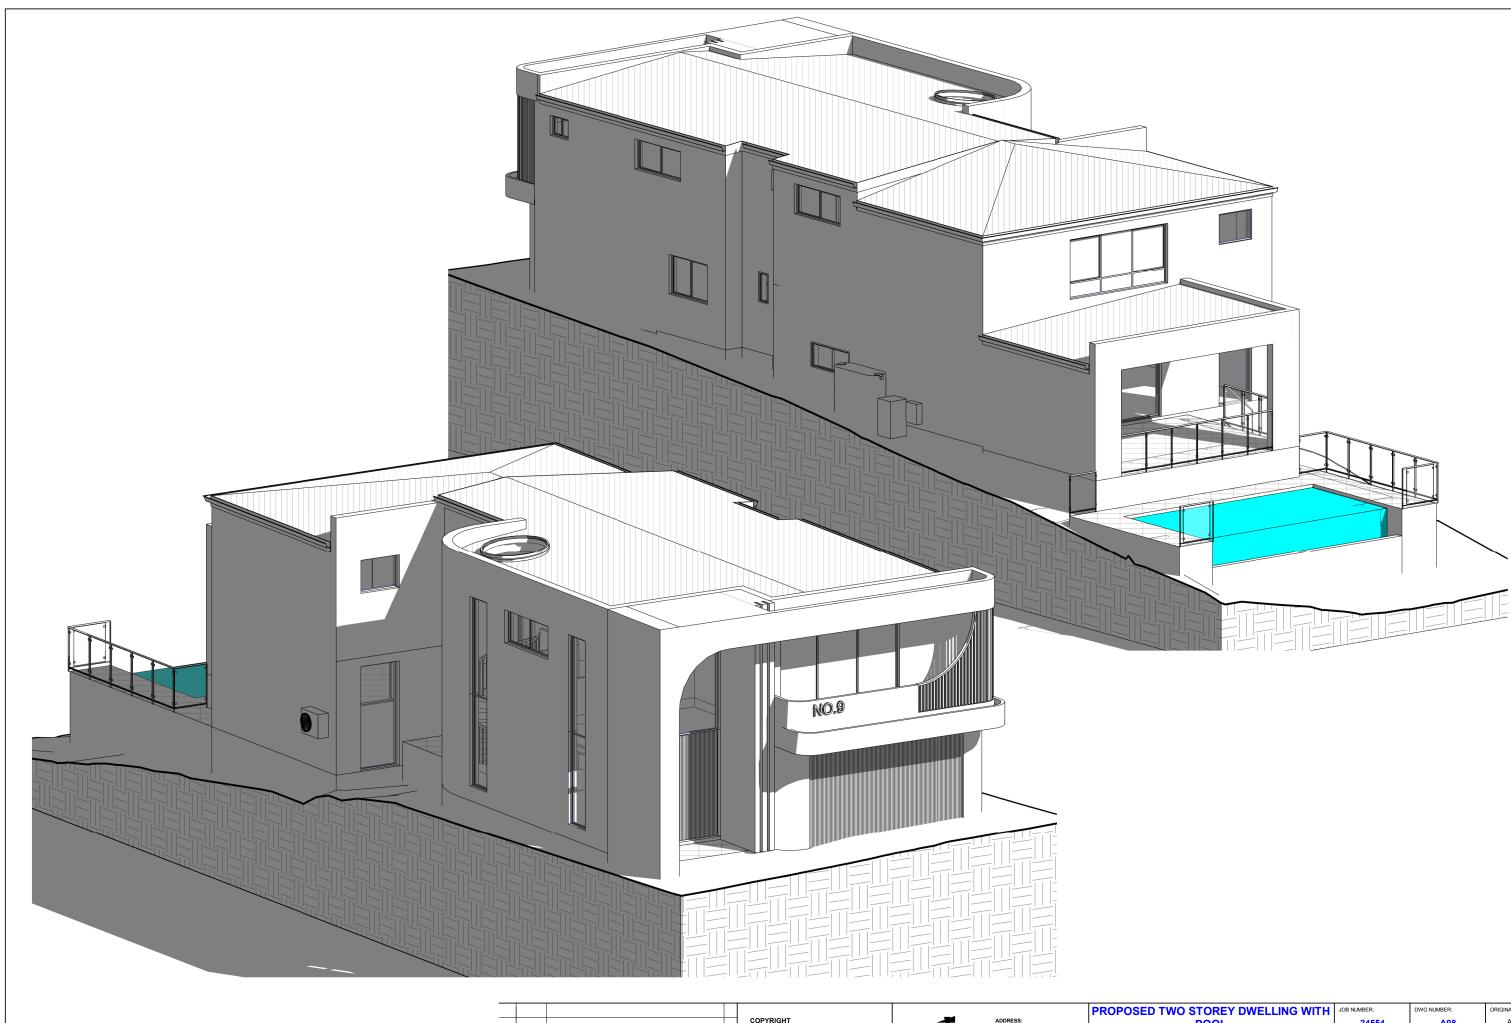
D STOREY DWELLING WITH	JOB NUMBER:	DWG NUMBER:	ORIGINAL SIZE:
POOL	24554	A06.01	A3
Y ROAD, PADSTOW HEIGHTS ot A, DP 409706	DESIGNED BY:	DATE: 15.11.2024	
	A.N.	15.11.2024	
TUDINAL SECTION	DRAWN BY:	SCALE:	
	A.N.	AS SHOWN	
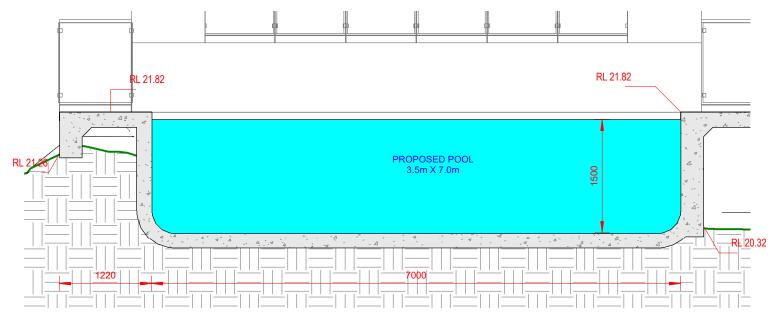
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O STOREY DWELLING WITH	JOB NUMBER:	DWG NUMBER:	ORIGINAL SIZE:
POOL	24554	A07	A3
Y ROAD, PADSTOW HEIGHTS .ot A, DP 409706	DESIGNED BY:	DATE: 15.11.2024	
	A.N.	15.11.2024	
ND AND FIRST FLOOR	DRAWN BY:	SCALE:	
	A.N.	AS SHOWN	

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SED TWO STOREY DWELLING WITH	JOB NUMBER:	DWG NUMBER:	ORIGINAL SIZE:
POOL	24554	A08	A3
UEENSBURY ROAD, PADSTOW HEIGHTS Lot A, DP 409706	DESIGNED BY:	DATE: 15.11.2024	
	A.N.	15.11.2024	
3D_MODEL	DRAWN BY:	SCALE:	
—	A.N.	AS SHOWN	

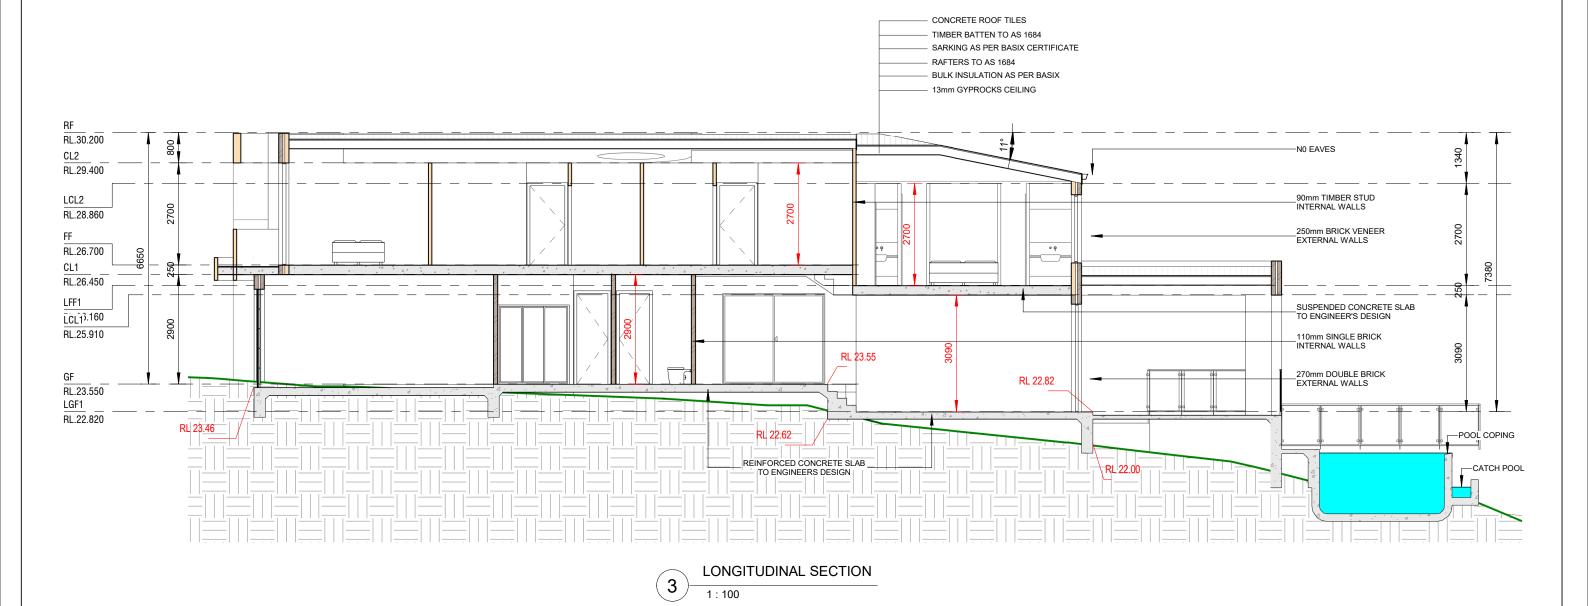

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D STOREY DWELLING WITH	JOB NUMBER:	DWG NUMBER:	ORIGINAL SIZE:
POOL	24554	A09	A3
Y ROAD, PADSTOW HEIGHTS ot A, DP 409706	DESIGNED BY:	DATE: 15.11.2024	
	A.N.	15.11.2024	
3D_MODEL	DRAWN BY:	SCALE:	
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WINDOWS SCHEDULE - DWELLING							
Mark	Height	Width	Area	Level			
			•				
W1	2900	1480	4.29 m ²	GF			
W2	1200	1810	2.17 m ²	GF			
W3	900	450	0.41 m²	GF			
W5	2850	1200	3.42 m ²	LGF1			
W6	2850	1200	3.42 m ²	LGF1			
W7	5150	850	4.38 m ²	GF			
W8	5150	850	4.38 m ²	GF			
W9	5150	850	4.38 m ²	GF			
W10	2950	2930	8.64 m ²	FF			
W11	600	850	0.51 m²	FF			
W12	900	2170	1.95 m ²	FF			
W13	600	850	0.51 m ²	FF			
W14	900	2170	1.95 m ²	FF			
W15	1800	3600	6.48 m ²	LFF1			
W16	900	1200	1.08 m ²	FF			
W17	900	1200	1.08 m ²	LFF1			
W18	2650	2700	7.16 m ²	FF			
W19	900	2170	1.95 m ²	FF			
W20	900	450	0.41 m ²	LGF1			
W21	750	1810	1.36 m ²	LGF1			
Grand total:	20	1	59.92 m²				

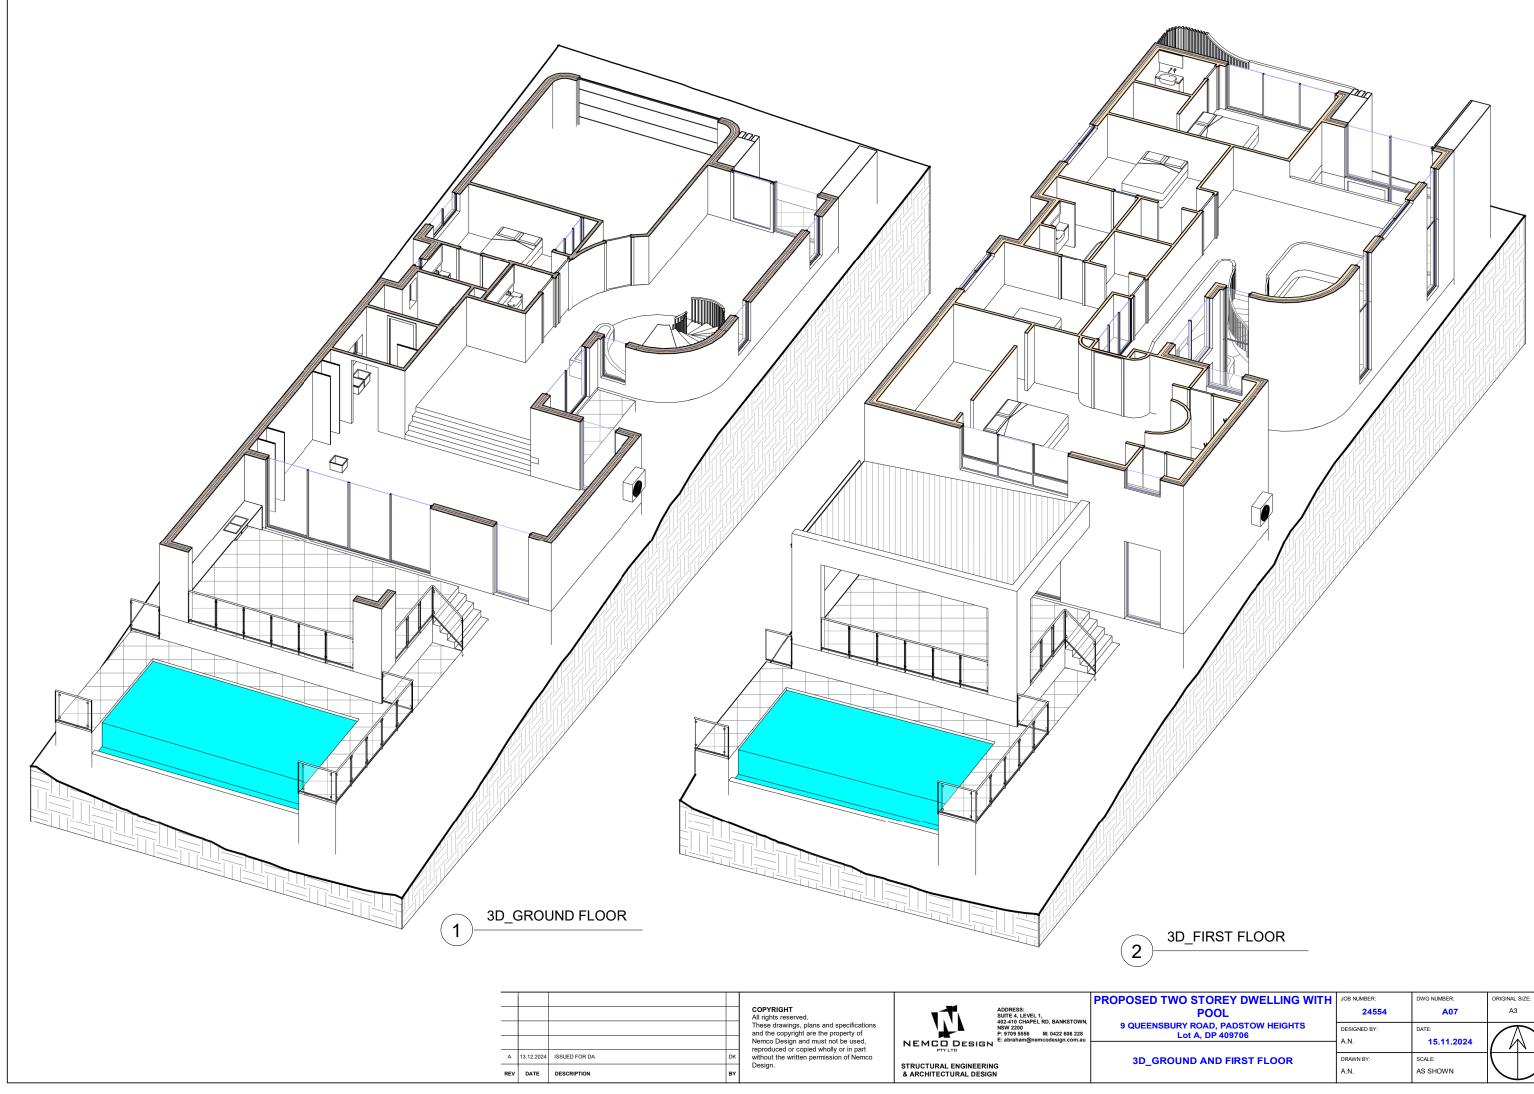GLASS DOORS SCHEDULE - DWELLING								
Mark	Height	Width	Area	Level				
SD1	2850	5600	15.96 m ²	LGF1				
SD2	2400	2700	6.48 m²	GF				
SD3	2700	3700	9.99 m²	FF				
Grand total:	3		32.43 m ²	,				

SKYLIGHT SCHEDULE									
Mark	Height	Width	Area	Level					
SK2.1	1800	1800	3.24 m²	CL2					
Grand to	otal: 1		3.24 m ²						

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POOL	24554	A10	A3
Y ROAD, PADSTOW HEIGHTS .ot A, DP 409706	DESIGNED BY:	DATE: 15.11.2024	
	7.N.	13.11.2024	
& DOORS SCHEDULE	DRAWN BY:	SCALE:	\setminus $/$
	A.N.	AS SHOWN	\checkmark







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							PROPOSED TWO




06: COLOURBOND ROOF

07: FASCIA & GUTTER

WO STOREY DWELLING WITH	JOB NUMBER:	DWG NUMBER:	ORIGINAL SIZE:
POOL	24554	A11	A3
BURY ROAD, PADSTOW HEIGHTS Lot A, DP 409706	DESIGNED BY: A.N.	DATE: 15.11.2024	
	A.N.	15.11.2024	
HEDULE OF FINISHES	DRAWN BY:	SCALE:	
	A.N.	AS SHOWN	\searrow


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QUEENSBURY ROAD




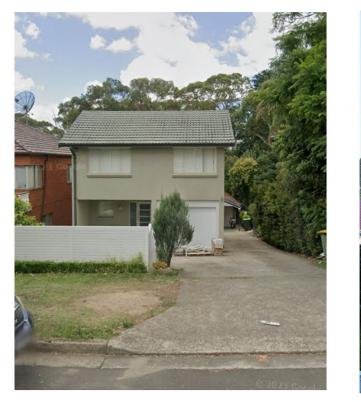

O STOREY DWELLING WITH	JOB NUMBER:	DWG NUMBER:	ORIGINAL SIZE:
POOL	24554	A12	A3
Y ROAD, PADSTOW HEIGHTS .ot A, DP 409706	DESIGNED BY:	DATE: 15.11.2024	
	A.N.	15.11.2024	
PE VIEW & FRONT FENCE	DRAWN BY: A.N.	SCALE: AS SHOWN	

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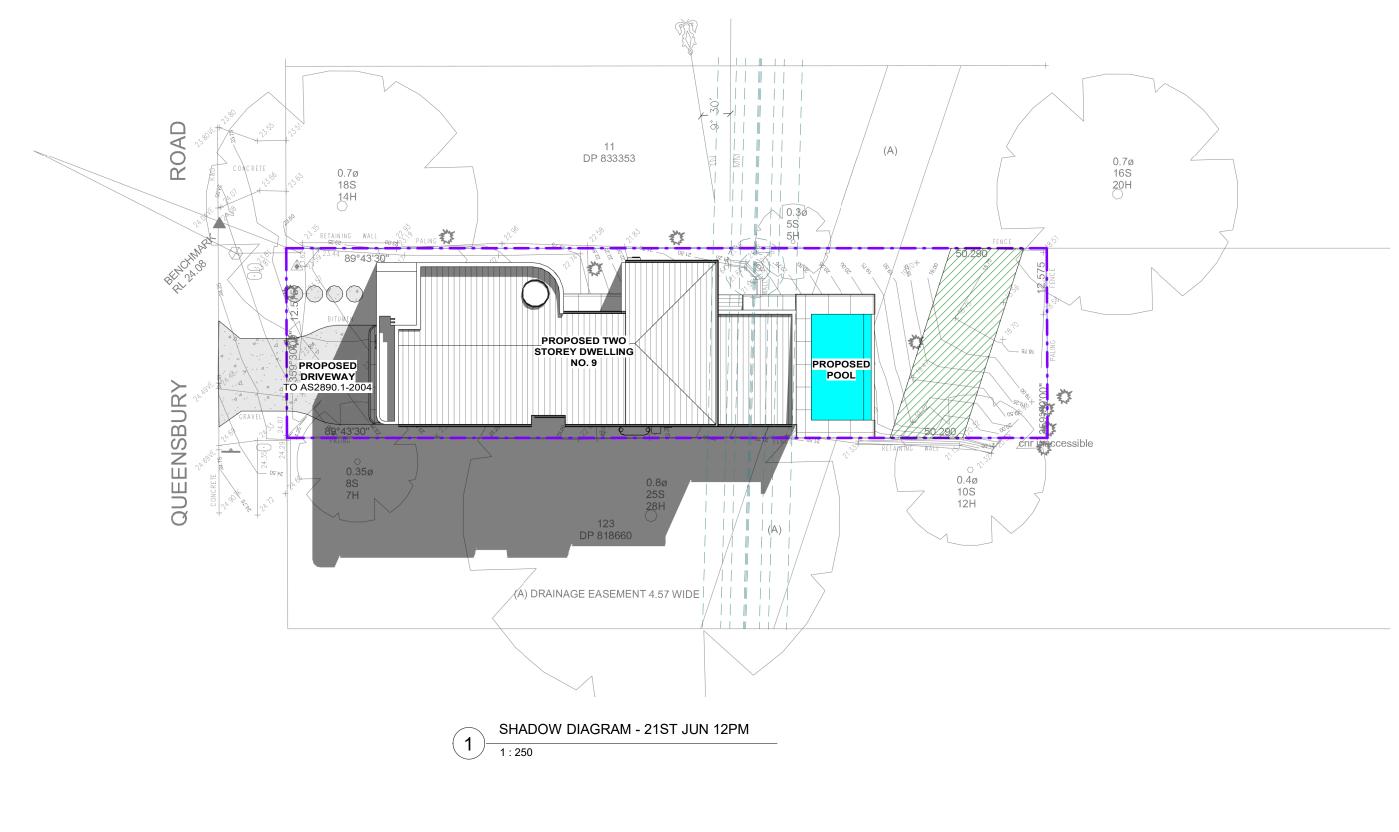
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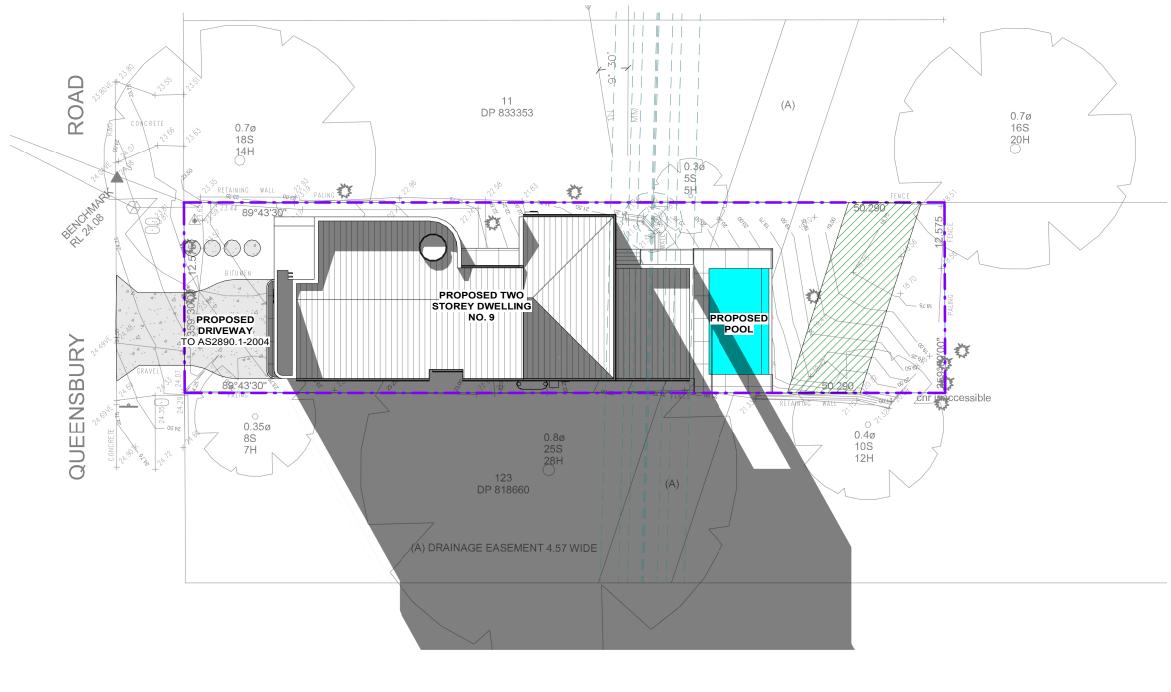
D STOREY DWELLING WITH	JOB NUMBER:	DWG NUMBER:	ORIGINAL SIZE:
POOL	24554	A13.01	A3
Y ROAD, PADSTOW HEIGHTS ot A, DP 409706	DESIGNED BY:	DATE: 15.11.2024	
	A.N.	15.11.2024	
AGRAM - 21ST JUN 8AM	DRAWN BY:	SCALE:	
	A.N.	AS SHOWN	\checkmark

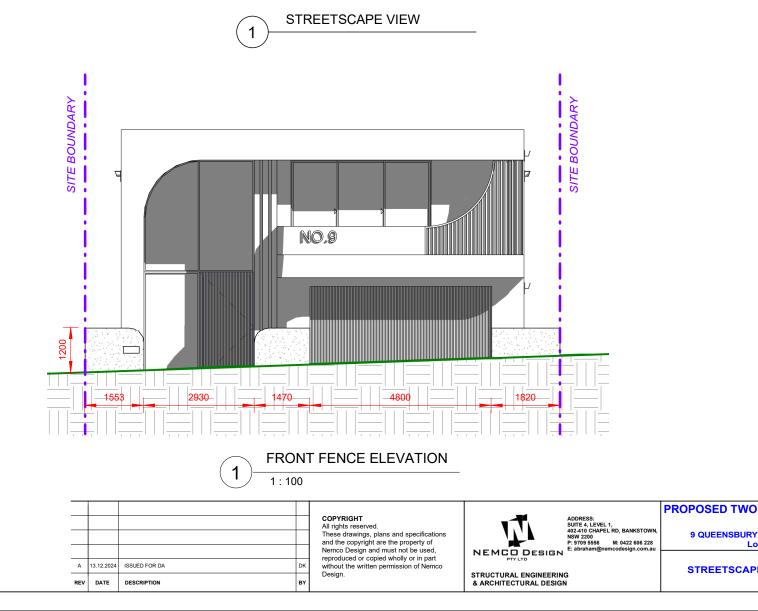
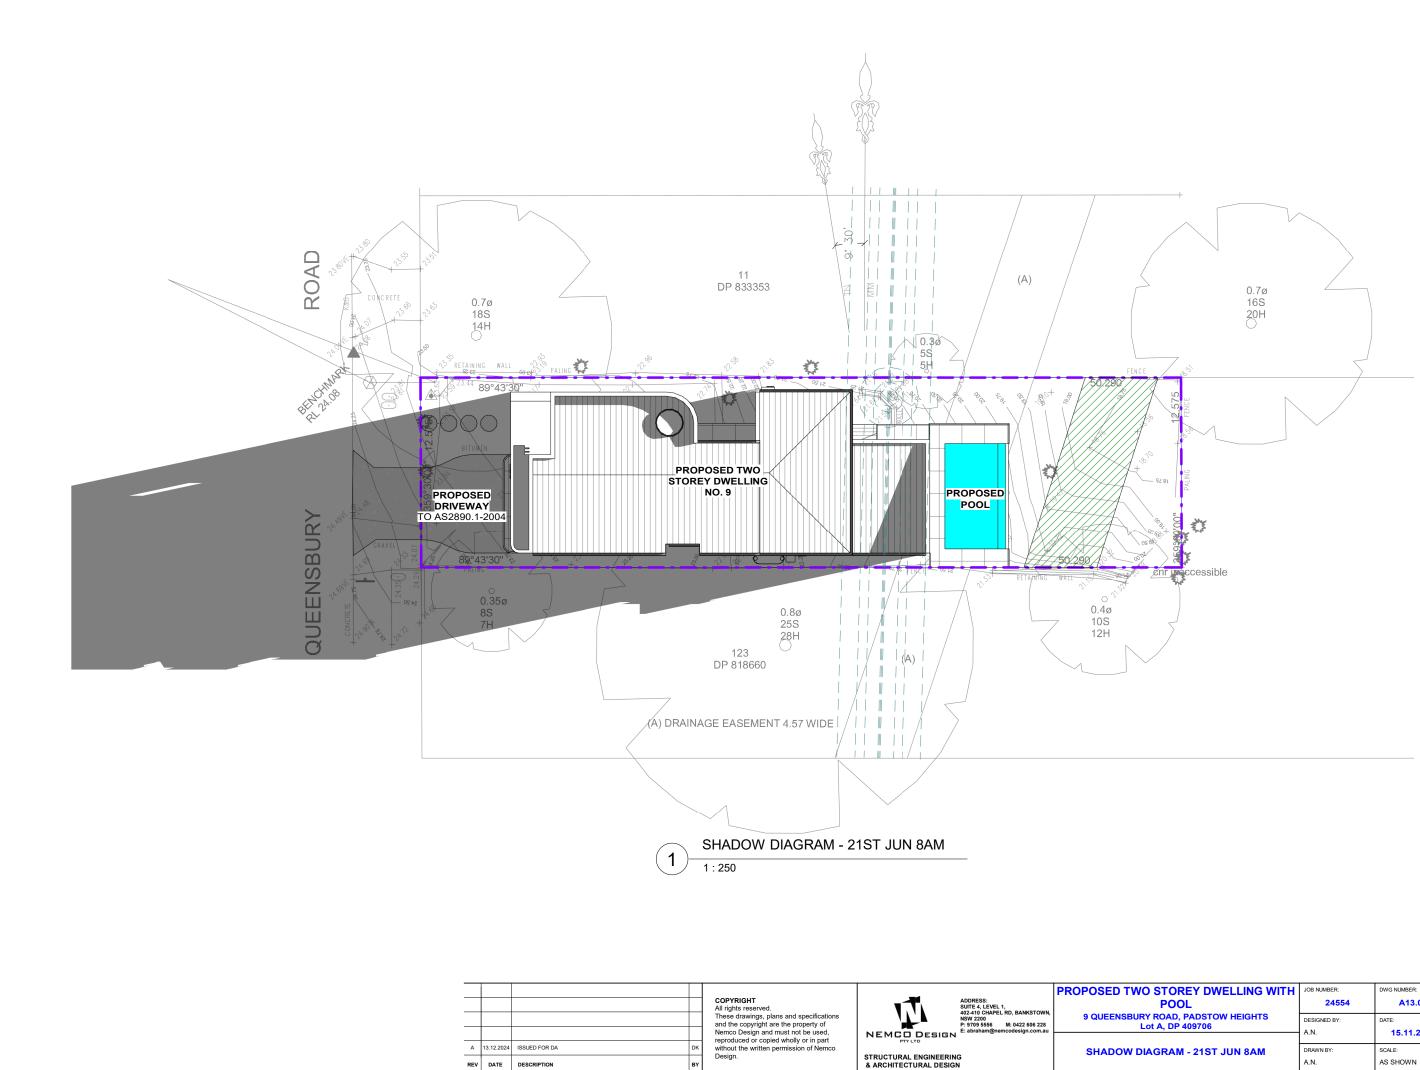
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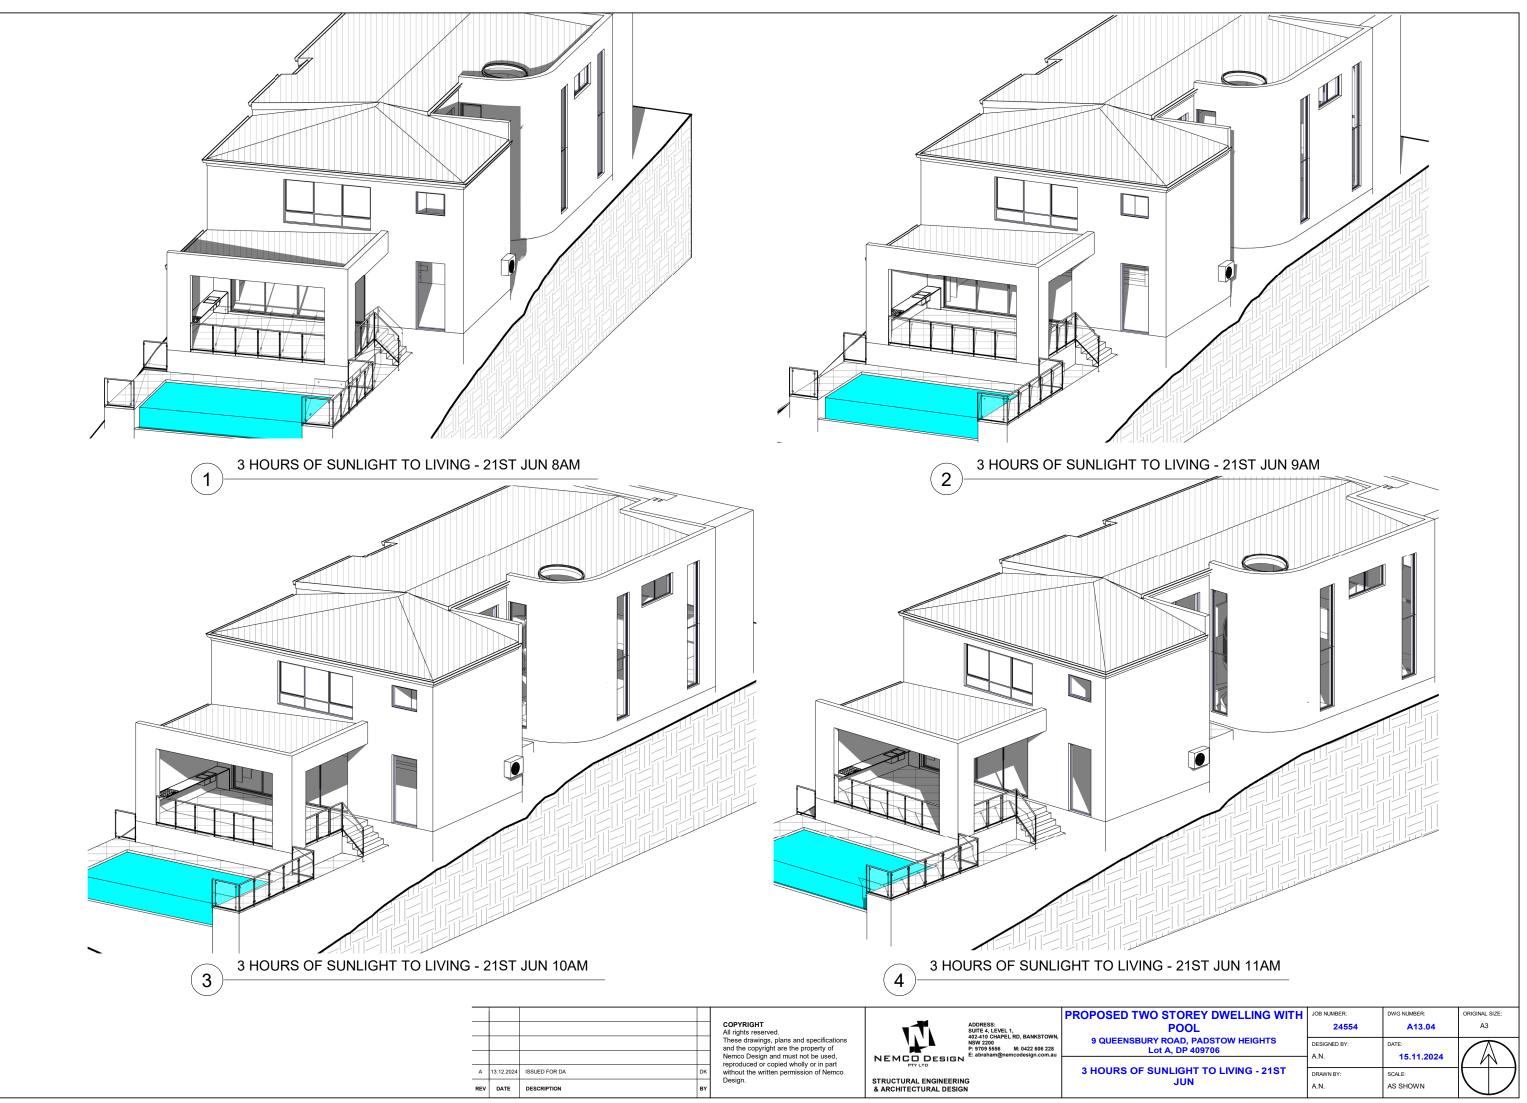
NO STOREY DWELLING WITH	JOB NUMBER:	DWG NUMBER:	ORIGINAL SIZE:
POOL	24554	A13.02	A3
URY ROAD, PADSTOW HEIGHTS Lot A, DP 409706	DESIGNED BY:	DATE: 15.11.2024	
	A.N.	15.11.2024	
DIAGRAM - 21ST JUN 12PM	DRAWN BY:	SCALE:	()
	A.N.	AS SHOWN	\searrow



SHADOW DIAGRAM - 21ST JUN 4PM 1 1 : 250


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A	13.12.2024	4 ISSUED FOR DA	DK	reproduced or copied wholly or in part without the written permission of Nemco		-	SHADOW DIAGRAM - 21ST JUN 4PM	DRAWN BY:	SCALE:		—)
REV	DATE	DESCRIPTION	BY	Design.	STRUCTURAL ENGINEERII & ARCHITECTURAL DESIG			A.N.	AS SHOWN		

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O STOREY DWELLING WITH	JOB NUMBER:	DWG NUMBER:	ORIGINAL SIZE:
POOL	24554	A13.04	A3
Y ROAD, PADSTOW HEIGHTS	DESIGNED BY:	DATE:	
ot A, DP 409706	A.N.	15.11.2024	
UNLIGHT TO LIVING - 21ST	DRAWN BY:	SCALE:	
JUN	A.N.	AS SHOWN	

12/03/2025 10:10:05 AM



			_
D STOREY DWELLING WITH	JOB NUMBER:	DWG NUMBER:	ORIGINAL SIZE:
POOL	24554	A13.05	A3
Y ROAD, PADSTOW HEIGHTS ot A, DP 409706	DESIGNED BY:	DATE: 15.11.2024	
	A.N.	15.11.2024	
SUNLIGHT TO 50% POS -	DRAWN BY:	SCALE:	
20TH MAR	A.N.	AS SHOWN	

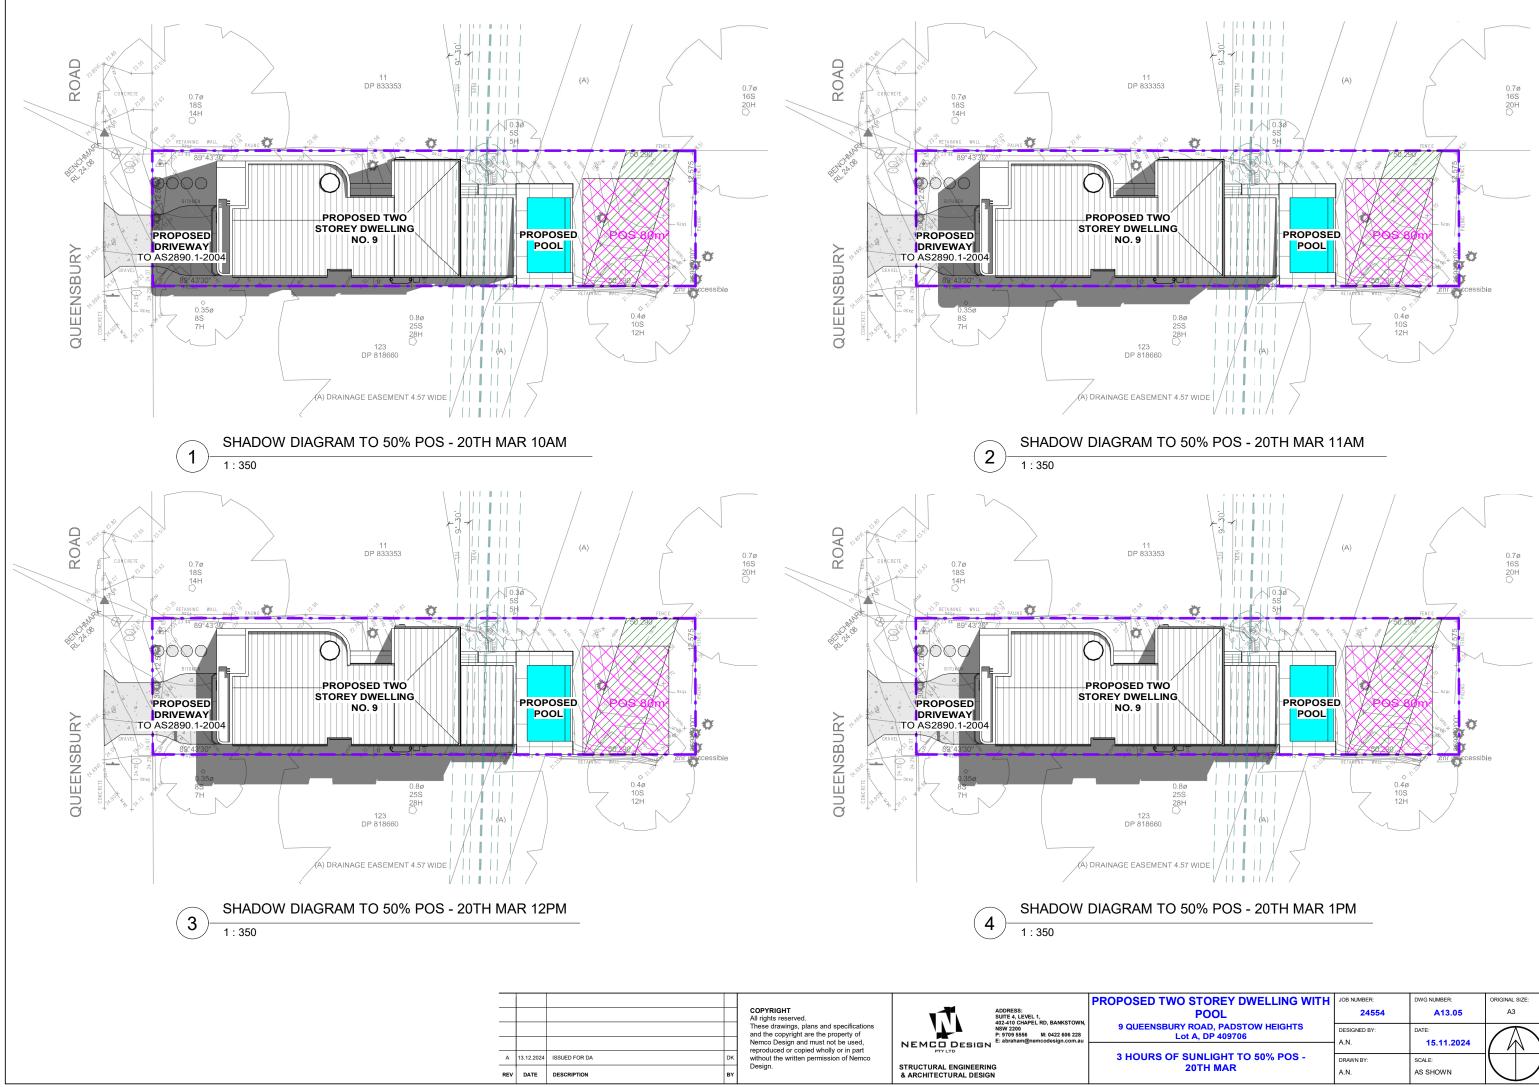12/03/2025 10:10:10 AM

BASIX[°]Certificate

Single	Dwel	ling

Certificate	number:	1778213S	

This certificate confi government's requin commitments set ou have the meaning gi 10/09/2020 publishe www.basix.nsw.gov. ms that the proposed development will meet the NSW

government's requirements for sustainability, if it is built in accordance with the	Project type
commitments set out below. Terms used in this certificate, or in the commitments, have the meaning given by the document entitled "BASIX Definitions" dated	No. of bedrooms
10/09/2020 published by the Department. This document is available at www.basix.nsw.gov.au	Project score
www.basix.nsw.gov.du	Water
Secretary Date of issue: Tuesday, 17 December 2024 To be valid, this certificate must be submitted with a development application or lodged with a	Thermal Performance
complying development certificate application within 3 months of the date of issue.	Energy



BASIX Department Infrastructu

9 QUEENBURY ROAD, PADSTOW HEIGHTS 9 QUEENSBURY ROAD PADSTOW HEIGHTS 2211 Canterbury-Bankstown Council Deposited Plan 409706 Local Government Area Plan type and plan number Lot no. Section no. dwelling hous ✓ 40 V Pass ✓ 74 -100

Project summary

Project name Street address

Certificate Prepared by						
Name / Comp	any Name: NEMCO DESIGN F	PTY. LTD.				
ABN (if applica	ble): 46166160505					
US_03_01_0	Certificate No.: 1778213S	Tuesday, 17 December 2024	page 1/13			

Target 40

Target Pass

Target 72

Target n/a

Description of project

Department of Planning, Housing and Infrastructure

BASIX

BASIX Department of F Infrastructure

Department of Planning, Housing and Infrastructure

Project name	9 QUEENBURY ROAD, PADSTOW HEIGHTS	Assessor number	n/a		
Street address	9 QUEENSBURY ROAD PADSTOW HEIGHTS	Certificate number	n/a		
	2211	Climate zone	n/a		
Local Government Area	Canterbury-Bankstown Council	Area adjusted cooling load (MJ/	n/a		
Plan type and plan number	Deposited Plan 409706	m².year)			
Lot no.	A	Area adjusted heating load (MJ/ m ² ,vear)	n/a		
Section no.	-				
Project type		Project score	_		
Project type	dwelling house (detached)	Water	✓ 40	Target 40	
No. of bedrooms	5	Thermal Performance	V Pass	Target Pas	
Site details			V Pass	Target Pas	
Site area (m²)	632	Energy	✓ 74	Target 72	
Roof area (m²)	239	Materials			
Conditioned floor area (m ²)	295.0	Menorheits	 -100 	Target n/a	
Unconditioned floor area (m ²)	28.7				
Total area of garden and lawn (m ²)	100				
Roof area of the existing dwelling (m ²)	0				

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Schedule of BASIX commitments

The commitments set out below regulate how the proposed development is to be carried out. It is a condition of any development consent granted, or complying development certificate issued, for the proposed development, that BASIX commitments be complied with.

Water Commitments	Show on	Show on CC/CDC	Certifier
Water Communents	DA plans	plans & specs	check
Fixtures			
The applicant must install showerheads with a minimum rating of 4 star (> 4.5 but <= 6 L/min plus spray force and/or coverage tests) in all showers in the development.		~	~
The applicant must install a toilet flushing system with a minimum rating of 4 star in each toilet in the development.		~	~
The applicant must install taps with a minimum rating of 4 star in the kitchen in the development.		~	
The applicant must install basin taps with a minimum rating of 4 star in each bathroom in the development.		~	
Alternative water			
Rainwater tank			
The applicant must install a rainwater tank of at least 1500 litres on the site. This rainwater tank must meet, and be installed in accordance with, the requirements of all applicable regulatory authorities.	~	~	*
The applicant must configure the rainwater tank to collect rain runoff from at least 239.34 square metres of the development (excluding the area of the roof which drains to any stormwater tank or private dam).		~	~
The applicant must connect the rainwater tank to:			
all toilets in the development		~	~
 at least one outdoor tap in the development (Note: NSW Health does not recommend that rainwater be used for human consumption in areas with potable water supply.) 		~	~
Swimming Pool			
The swimming pool must not have a volume greater than 40 kilolitres.			

BASIX Department of Planning, Housing and www.basix.nsw.gov.au Version: 4.03 / EUCAL/YPTUS_03_01_0 Certificate No.: 1778213S Tuesday, 17 December 2024 Infrastructure page 3/1:

Thermal Performance and	Materials commitme	nts		Show on DA plans	Show on CC/CDC plans & specs	Certifie check	
Do-it-yourself Method							
General features							
The dwelling must be a Class 1 dw	elling according to the Nation	onal Construction Code, and must not have m	tore than 2 storeys.	~	~	~	
The conditioned floor area of the de	welling must not exceed 30	0 square metres.		~	×	•	
The dwelling must not contain oper	n mezzanine area exceedin	g 25 square metres.		~	~	~	
The dwelling must not contain third	he dwelling must not contain third level habitable attic room.						
Floor, walls and ceiling/roof							
The applicant must construct the fle below.	oor(s), walls, and ceiling/roo	of of the dwelling in accordance with the speci	fications listed in the table	~	~	~	
The applicant must adopt one of th ceiling/roof of the dwelling.	e options listed in the table	s below to address thermal bridging in metal f	ramed floor(s), walls and	~	~	~	
The applicant must show through r the tables below.	eceipts that the materials p	urchased for construction are consistent with	the specifications listed in			~	
Construction	1					_	
Construction	Area - m²	Additional insulation require	d Options to address t bridging	thermal	Other specification:		
floor - concrete slab on ground, waffle pod slab.	154.6	nil;not specified	ni				
floor - above habitable rooms or mezzanine, plywood; frame: laminated veneer lumber (LVL)	134.58	nil;rockwool batts, roll or pump-	in nil				
floor - suspended floor above garage, plywood; frame: timber - H2 treated softwood.	32.52	nil;rockwool batts, roll or pump-	in nil				

Additional insulation required Options to address thermal Other specifications polystynene nil nstruction Area - m²
 garage floor - concrete slab on ground, waffle pod slab.
 3

 external wall: brick veneer; frame: timber - H2 treated softwood.
 1
 2.94 (or 3.50 including construction);rockwool batts, roll or pump-in + reflective foil in the cavity 0.50 (or 1.20 including construction);rockwool batts, roll or pump-in + reflective foil in the cavity wall colour: Medium (solar absorptance 0.48-0.7) wall colour: Medium (solar absorptance 0.48-0.7) external wall: cavity brick; frame: no frame. rockwool batts, roll or pump-in reflective foil in the cavity external garage wall: cavity brick; frame: no frame. internal wall shared with garage: single skin masonry; frame: no frame. kwool batts, roll or pu frame. internal wall: single skin masonry: frame: no frame. internal wall: plasterboard; frame: timber - H2 treated softwood. ceiling and roof - flat ceiling / pitched roof, framed - metal roof, laminated veneer lumber (LVL). ockwool batts, roll or pump-i rockwool batts, roll or pump-in ceiling: 5.7 (up), roof: foil/ sarking ;ceiling: rockwool batts, roll or pump-in; roof: foil/sarking roof space ventilation: wind-driven ventilation(s) + eave vents; roof colour: medium (solar absorptance 0.48-0.59); 0.5 to _ 1.0% of ceiling area uninsulated roof colour: medium (solar absorptance 0.48-0.59); 0.5 to _ 1.0% of ceiling area uninsulated ceiling: 5.7 (up), roof: foil/ sarking ;ceiling: rockwool batts, roll or pump-in; roof: foil/sarking ceiling and roof - flat ceiling / flat roof, framed - metal roof, laminated veneer lumber (LVL).
 Note
 Installation specified in this Certificate must be installed in accordance with the ABCB Housing Provisions (Part 13.2.2) of the National Construction Code.

 Note
 If the additional celling insulation Isled in the tables above is greater than R3.0, refer to the ABCB Housing Provisions (Part 13.2.2) of the National Construction Code.

 Note
 If the additional celling insulation Isled in the tables above is greater than R3.0, refer to the ABCB Housing Provisions (Part 13.2.2) of the National Construction Code.

 Note
 In some climate zones, insulation should be installed with due consideration of condensation and associated interaction with adjoining building materials.

 Note
 Thermal breaks must be installed in metal framed walls and applicable roofs in accordance with the ABCB Housing Provisions of the National Construction Code.

hermal Performance and Materials	commitments		S	how on A plans	Show on CC/CDC plans & specs	Certifier check
eiling fans						
he applicant must install at least one ceiling far	n in at least one daytime	habitable space, such as living room.		~	~	~
The minimum number and diameter of ceiling fousing Provisions (Part 13.5.2) of the National	fans in a daytime habital I Construction Code .	ble space must be installed in accordance	e with the ABCB	 Image: A second s	~	~

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Glazed window/door no.	Maximum height (mm)	Maximum width (mm)	Frame and glass specification	Shading device (Dimension within 10%)	Overshadowing
W9	2400.00	850.00	aluminium, single glazed (U- value: <=6.0, SHGC: 0.60 - 0.74)	none	2-4 m high, 5-8 m away
W18	2650.00	2700.00	aluminium, single glazed (U- value: <=6.0, SHGC: 0.60 - 0.74)	none	2-4 m high, 5-8 m away
W19	900.00	2170.00	aluminium, single glazed (U- value: <=6.0, SHGC: 0.60 - 0.74)	none	2-4 m high, 5-8 m away
SD2	2400.00	2400.00	aluminium, single glazed (U- value: <=7.5, SHGC: 0.74 - 0.90)	none	2-4 m high, 5-8 m away
East facing					
W5	2100.00	900.00	aluminium, single glazed (U- value: <=6.0, SHGC: 0.60 - 0.74)	none	2-4 m high, 5-8 m away
W15	1200.00	2100.00	aluminium, single glazed (U- value: <=6.0, SHGC: 0.60 - 0.74)	none	2-4 m high, 5-8 m away
W16	900.00	1200.00	aluminium, single glazed (U- value: <=6.0, SHGC: 0.60 - 0.74)	none	2-4 m high, 5-8 m away
SD1	2100.00	2400.00	aluminium, single glazed (U- value: <=6.0, SHGC: 0.60 - 0.74)	none	not overshadowed
W7	2100.00	850.00	aluminium, single glazed (U- value: <=6.0, SHGC: 0.60 - 0.74)	none	2-4 m high, 5-8 m away
South facing					
W4	900.00	450.00	aluminium, single glazed (U- value: <=6.0, SHGC: 0.60 - 0.74)	none	not overshadowed

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Legend
In these commitments, "applicant" means the person carrying out the development.
Commitments identified with a 🂙 in the "Show on DA plans" column must be shown on the plans accompanying the development application for the proposed development (if a development application is to be lodged for the proposed development).
Commitments identified with a 🂙 in the "Show on CCICDC plans and specification must be shown in the plans and specifications accompanying the application for a construction certificate / complying development certificate for the proposed development.
Commitments identified with a 🇹 in the "Certifier check" column must be certified by a certifying authority as having been fulfilled, before a final occupation certificate (either interim or final) for the development may be issued.

Department of Planning, Housing and www.basix.new.gov.au Version: 4.03 / EUCALYPTUS_03_01_0 Certificate No:: 1778213S Tuesday, 17 December 2024 page 13/13 Infrastructure

Glazed window/door no.	Maximum height (mm)	Maximum width (mm)	Frame and glass specification	Shading device (Dimension within 10%)	Overshadowing
W20	750.00	1810.00	aluminium, single glazed (U- value: <=6.0, SHGC: 0.60 - 0.74)	none	not overshadowed
W3	900.00	450.00	aluminium, single glazed (U- value: <=6.0, SHGC: 0.60 - 0.74)	none	not overshadowed
W11	600.00	850.00	aluminium, single glazed (U- value: <=6.0, SHGC: 0.60 - 0.74)	none	not overshadowed
W13	600.00	850.00	aluminium, single glazed (U- value: <=6.0, SHGC: 0.60 - 0.74)	none	not overshadowed
W14	900.00	2170.00	aluminium, single glazed (U- value: <=6.0, SHGC: 0.60 - 0.74)	none	not overshadowed
West facing					
W1	2100.00	1200.00	aluminium, single glazed (U- value: <=6.0, SHGC: 0.60 - 0.74)	eave 450 mm, 300 mm above head of window or glazed door	2-4 m high, 5-8 m away
W17	900.00	1200.00	aluminium, single glazed (U- value: <=6.0, SHGC: 0.60 - 0.74)	eave 450 mm, 300 mm above head of window or glazed door	2-4 m high, 5-8 m away

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Energy Commitments	Show on DA plans	Show on CC/CDC plans & specs	Certifie check
Hot water			
The applicant must install the following hot water system in the development, or a system with a higher energy rating: electric boosted solar with a performance of 31 to 35 STCs or better.	~	~	~
Cooling system			
The applicant must install the following cooling system, or a system with a higher energy rating, in at least 1 living area: 1-phase airconditioning - ducted; Energy rating: 4.5 Star (old label)		~	~
The applicant must install the following cooling system, or a system with a higher energy rating, in at least 1 bedroom: 1-phase airconditioning - ducted; Energy rating: 4,5 Star (old label)		~	~
Heating system			
The applicant must install the following heating system, or a system with a higher energy rating, in at least 1 living area: 1-phase airconditioning - ducted; Energy rating: 4.5 Star (old label)		~	~
The applicant must install the following heating system, or a system with a higher energy rating, in at least 1 bedroom: 1-phase airconditioning - ducted; Energy rating: 4.5 Star (old label)		~	~
Ventilation			
The applicant must install the following exhaust systems in the development:			
At least 1 Bathroom: individual fan, ducted to façade or roof; Operation control: manual switch on/off		v	~
Kitchen: individual fan, open to façade; Operation control: manual switch on/off		 	~
Laundry: individual fan, ducted to façade or roof; Operation control: manual switch on/off		~	~
Artificial lighting			
The applicant must ensure that a minimum of 80% of light foxtures are fitted with fluorescent, compact fluorescent, or light-emitting- diode (LED) lamps.		~	~
Natural lighting			
The applicant must install a window and/or skylight in the kitchen of the dwelling for natural lighting.	~	~	~

				COPYRIGHT All rights reserved. These drawings, plans and specifications and the copyright are the property of	E E	ADDRESS: SUITE 4, LEVEL 1, 402-410 CHAPEL RD, BANKSTOWN, NSW 2200 P: 9709 5556 M: 0422 606 228	PROPOSED TWO 9 QUEENSBURY
				Nemco Design and must not be used, reproduced or copied wholly or in part		E: abraham@nemcodesign.com.au	LU
Α	13.12.2024	ISSUED FOR DA	DK	without the written permission of Nemco		_	BASIX
REV	DATE	DESCRIPTION	вү	Design.	STRUCTURAL ENGINEERIN & ARCHITECTURAL DESIGI		

Tuesday, 17 December 2024

BASIX Department of Infrastructure


Vater Commitments	Show on DA plans	Show on CC/CDC plans & specs	Certifier check
he swimming pool must have a pool cover.		~	
he swimming pool must be shaded.	~	~	
he swimming pool must be outdoors.	~	~	
Department of Planning, Housing and www.basix.nsw.gov.au Version: 4.03 / EUCALYPTUS_03_01_0 Certificate No.: 177821	IS Tur	isday, 17 December 2024	pag
Infrastructure			
ermal Performance and Materials commitments	Show on DA plans	Show on CC/CDC plans & specs	Certifier check
zed windows, doors and skylights			1
e applicant must install the windows, glazed doors and shading devices described in the table below, in accordance with the ecifications listed in the table. Relevant overshadowing specifications must be satisfied for each glazed window and door.	×	✓	×
a dwelling may have 1 skylight (<0.7 square metres) which is not listed in the table.	~	~	~
e following requirements must also be satisfied in relation to each window and glazed door:	~	~	~
The applicant must install windows and glazed doors in accordance with the height and width, frame and glazing types listed in the le.	~	~	
re. Tach window and glazed door must have a U-value no greater than that listed and a Solar Heat Gain Coefficient (SHGC) within the rege listed. Total system U values and SHGC must be calculated in accordance with National Fenestration Rating Council (NFRC) mildions.		~	~
Dvershadowing buildings/vegetation must be of the height and distance from the centre and the base of the window and glazed door, specified in the 'overshadowing' column.	~	~	~
e applicant must install the skylights described in the table below, in accordance with the specifications listed in the table. Total cylight area must not exceed 3 square metres (the 3 square metre limit does not include the optional additional skylight of less than 7 square metres that does not have to be listed in the table).	~	~	~

Skylight no. Maximum		Maximum area (m²)		Skylight specification		Shading device	
SK2.1 2.54		2.54		aluminium, single clear (U: <=7.3, SHGC: 0.75 - 0.83)		no shading	
Glazed window/door no.	Maximum height (mm)		Maximum width (mm)	Frame and glass specification	Shading devi (Dimension v		Overshadowing
North facing							
W8	2400.00		850.00	aluminium, single glazed (U- value: <=6.0, SHGC: 0.60 - 0.74)	none		2-4 m high, 5-8 m away

BASIX Department of Pla Infrastructure anning, Housing and www.basix.nsw.gov.au Version: 4.03 / EUCALYPTUS_03_01_0 Certificate No.: 1778213S

Energy Commitments	Show on DA plans	Show on CC/CDC plans & specs	Certifier check	
The applicant must install a window and/or skylight in 4 bathroom(s)/toilet(s) in the development for natural lighting.	~	~	<	
Swimming pool				
The applicant must install the following heating system for the swimming pool in the development (or alternatively must not install any heating system for the swimming pool): solar only		~		
The applicant must install the following pump for the swimming pool in the development, or a pump with a higher energy rating: single speed with a performance of 5 stars.		~		
The applicant must install a timer for the swimming pool pump in the development.		~		
Alternative energy				
The applicant must install a photovoltaic system as part of the development. The applicant must connect this system to the development's electrical system.	~	~	~	
The photovolatic system must consist of:				
 photovolatic collectors with the capacity to generate at least 1.5 peak kilowatts of electricity, installed at an angle between 0 degrees and 10 degrees to the horizontal facing north east 	~	~	~	
Other				
The applicant must install a fixed outdoor clothes drying line as part of the development.		~		

WO STOREY DWELLING WITH	JOB NUMBER:	DWG NUMBER:	ORIGINAL SIZE:
POOL	24554	A14	A3
URY ROAD, PADSTOW HEIGHTS Lot A, DP 409706	DESIGNED BY:	DATE: 15.11.2024	
	A.N.	15.11.2024	
SIX REQUIREMENTS	DRAWN BY:	SCALE:	()
	A.N.	AS SHOWN	$ \setminus \rangle$

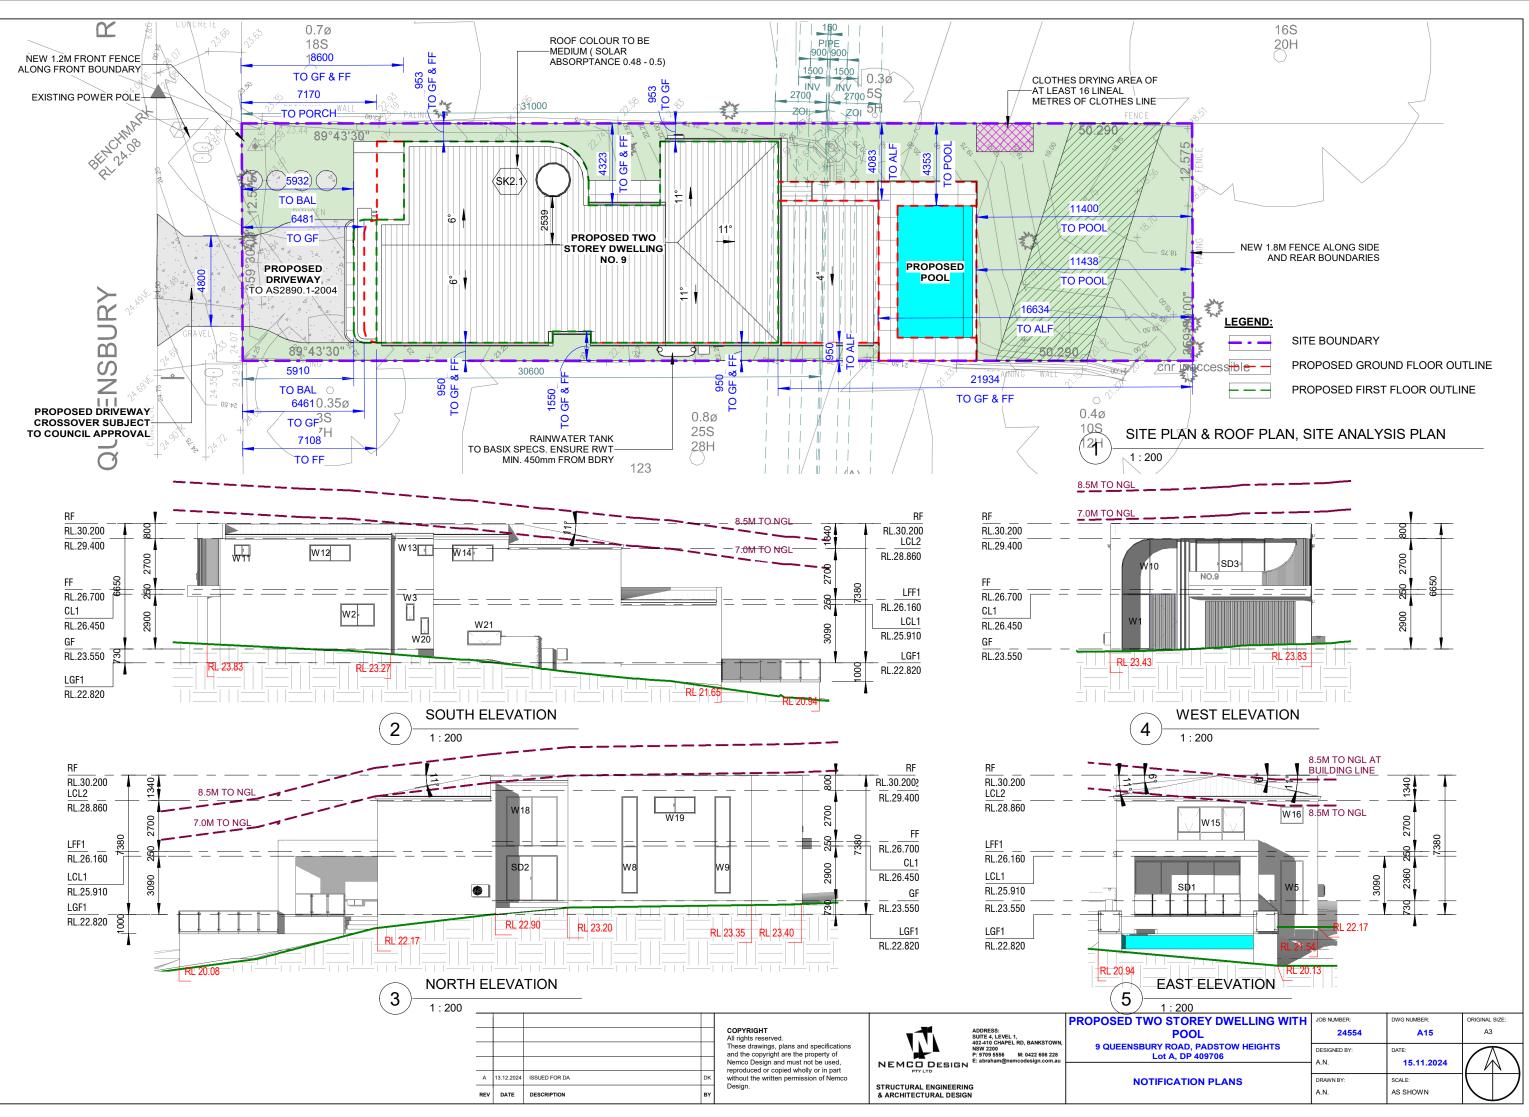

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